

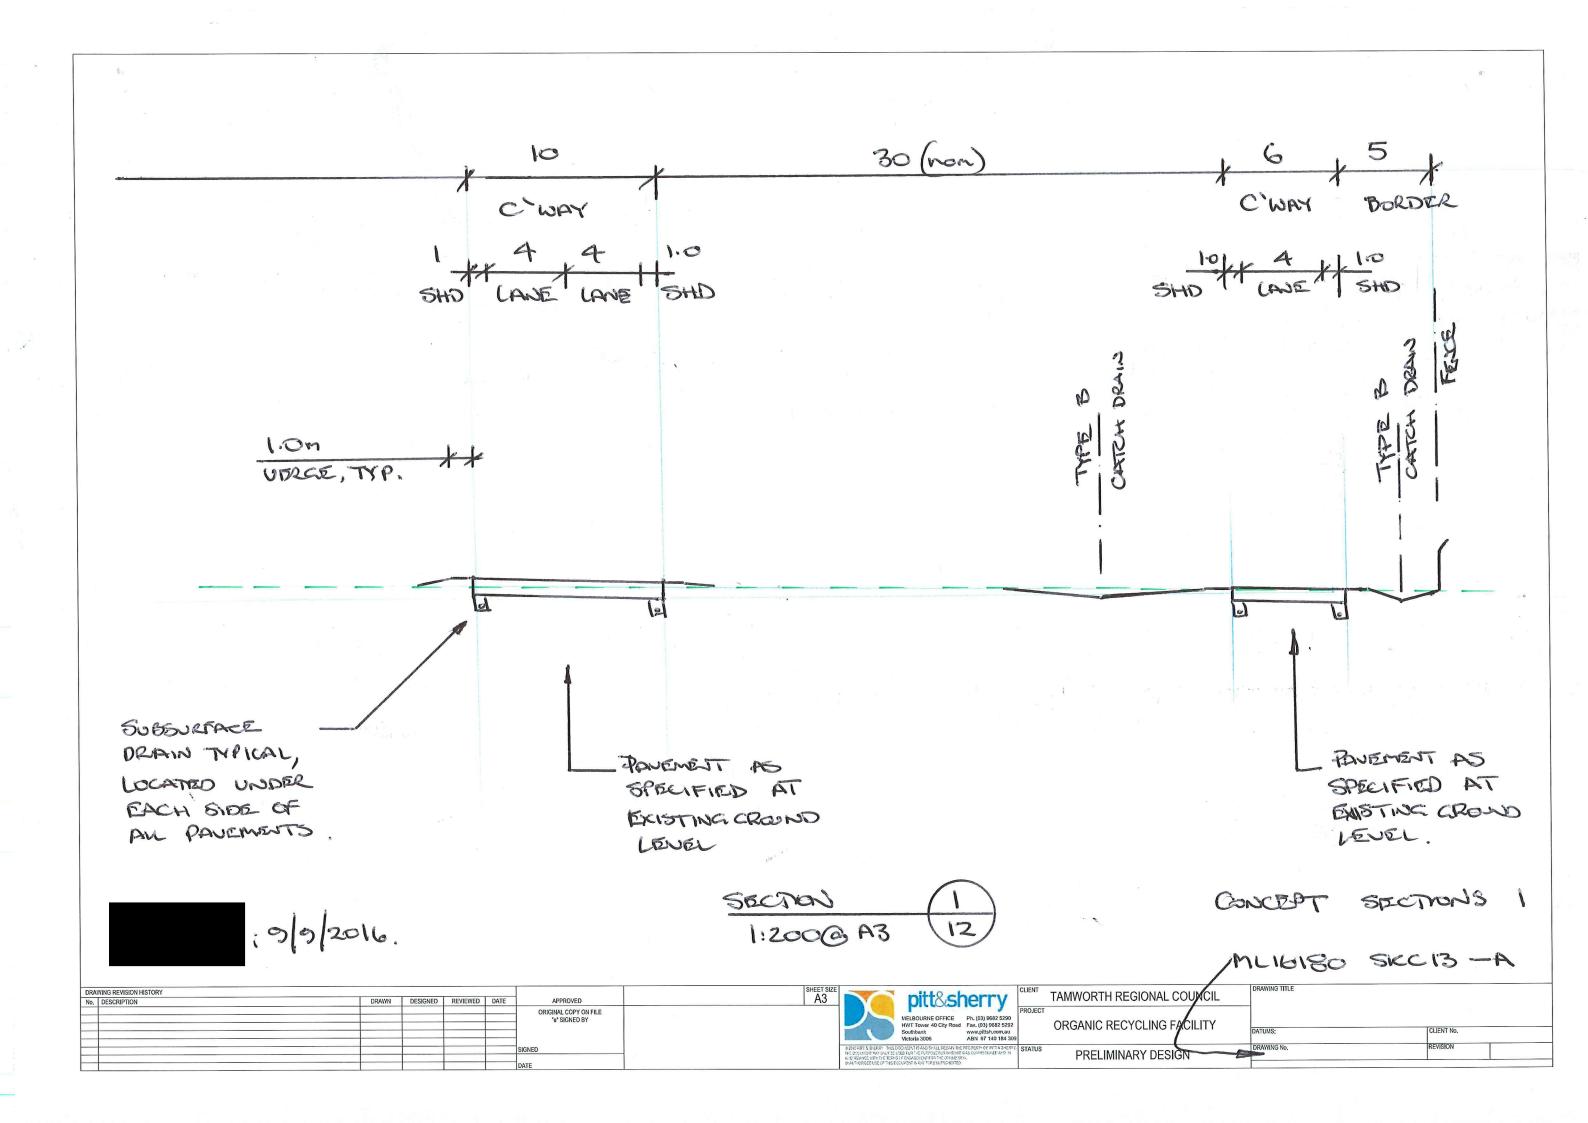



PLUMAY TYPE I BEACHING ADD TAT: 10m 10m NOMINAL AREA SPILLWAY, TYPE I BEACHING CONCEPT GRADING PLAN SHEET 2					
BOADS WITHOUT CONTOURS BISPLAYED FOLLOW EXSTING GROUND LEVEL CLOSELY				4	2
SPILLWAY, TYPE 1 BEACHING LAID FLAT. 10m*10m NOMINAL AREA. SPILLWAY, TYPE 1 BEACHING LAID FLAT. 10m*10m NOMINAL AREA. WARNING BEWARE OF UNDERGROUND SERVICES The localizes of underground services store position should be proven on site. NCIL PRAVING TITLE CONCEPT GRADING PLAN SHEET 2			DISPLAYED FOLLO	OW EXISTING	
SPILLWAY. TYPE 1 BEACHING LAID FLAT. 10m*10m NOMINAL AREA. WARE OF UNDERGROUND SERVICES The locations of underground services shown are approximate only and their exact position should be proven on site.				4 5K16	
SPILLWAY, TYPE 1 BEACHING LAID FLAT. 10m*10m NOMINAL AREA. WARNING BEWARE OF UNDERGROUND SERVICES The locations of underground services shown are approximate only and their exact position should be proven on sile. NCIL DRAWING TITLE CONCEPT GRADING PLAN SHEET 2					
AID FLAT. 10m*10m NOMINAL AREA. WARNING BEWARE OF UNDERGROUND SERVICES The locations of underground services shown are approximate only and their exact position should be proven on sile. NCIL DRAWING TITLE CONCEPT GRADING PLAN SHEET 2	4.00				
NCIL CONCEPT GRADING PLAN SHEET 2	SPILLWAY, TYF LAID FLAT. 10m	YE 1 BEACHING I*10m NOMINAL AREA.	BEWARE OF The locat shown are a	F UNDERGROUND SERVICE ions of underground services pproximate only and their exac	
SHEET 2	NCIL			PLAN	
LIIT DATUMS: CLIENT No.	LITY	DATUMS:	SHEET 2		
DRAWING No. ML16180-SKC012 REVISION C			SKC012		

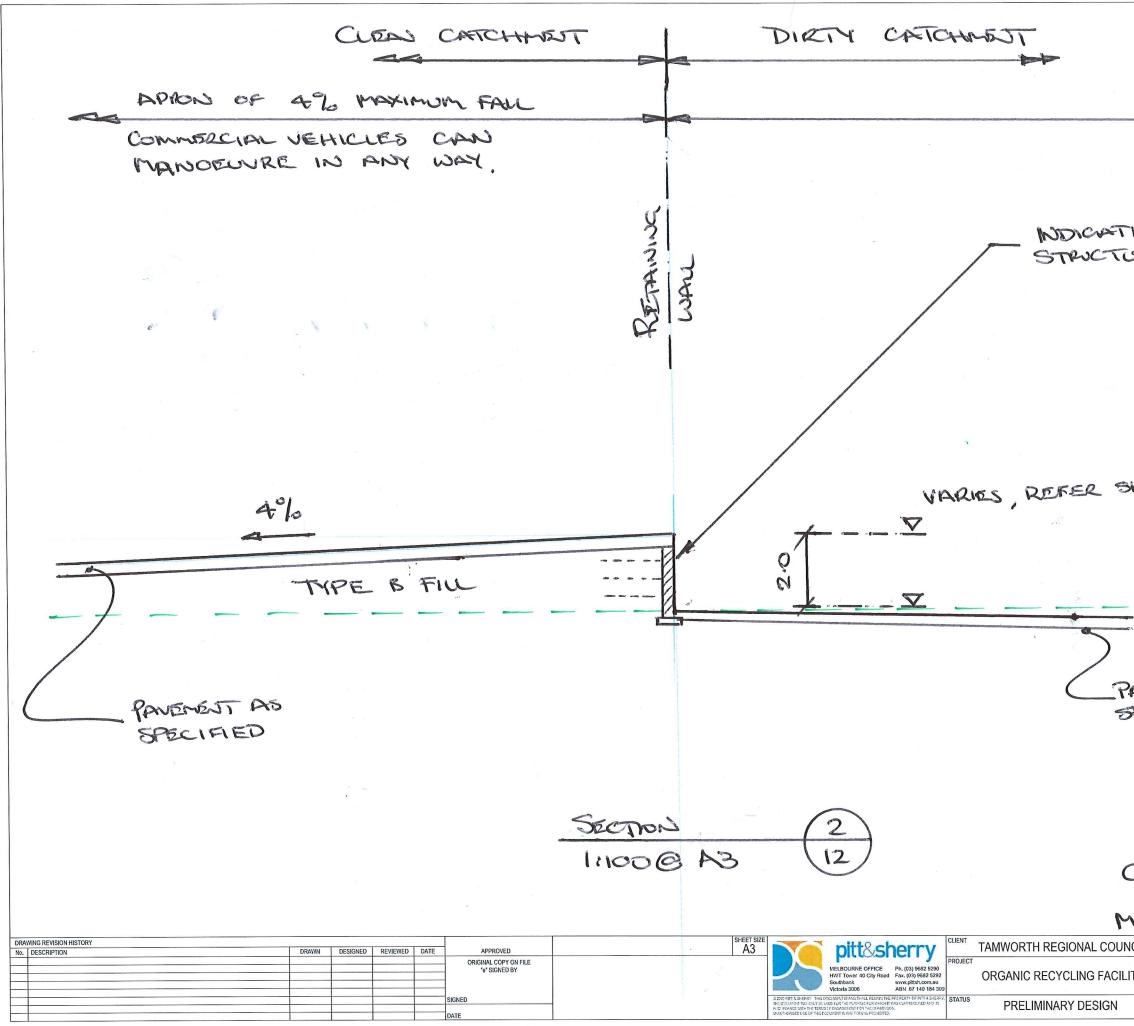

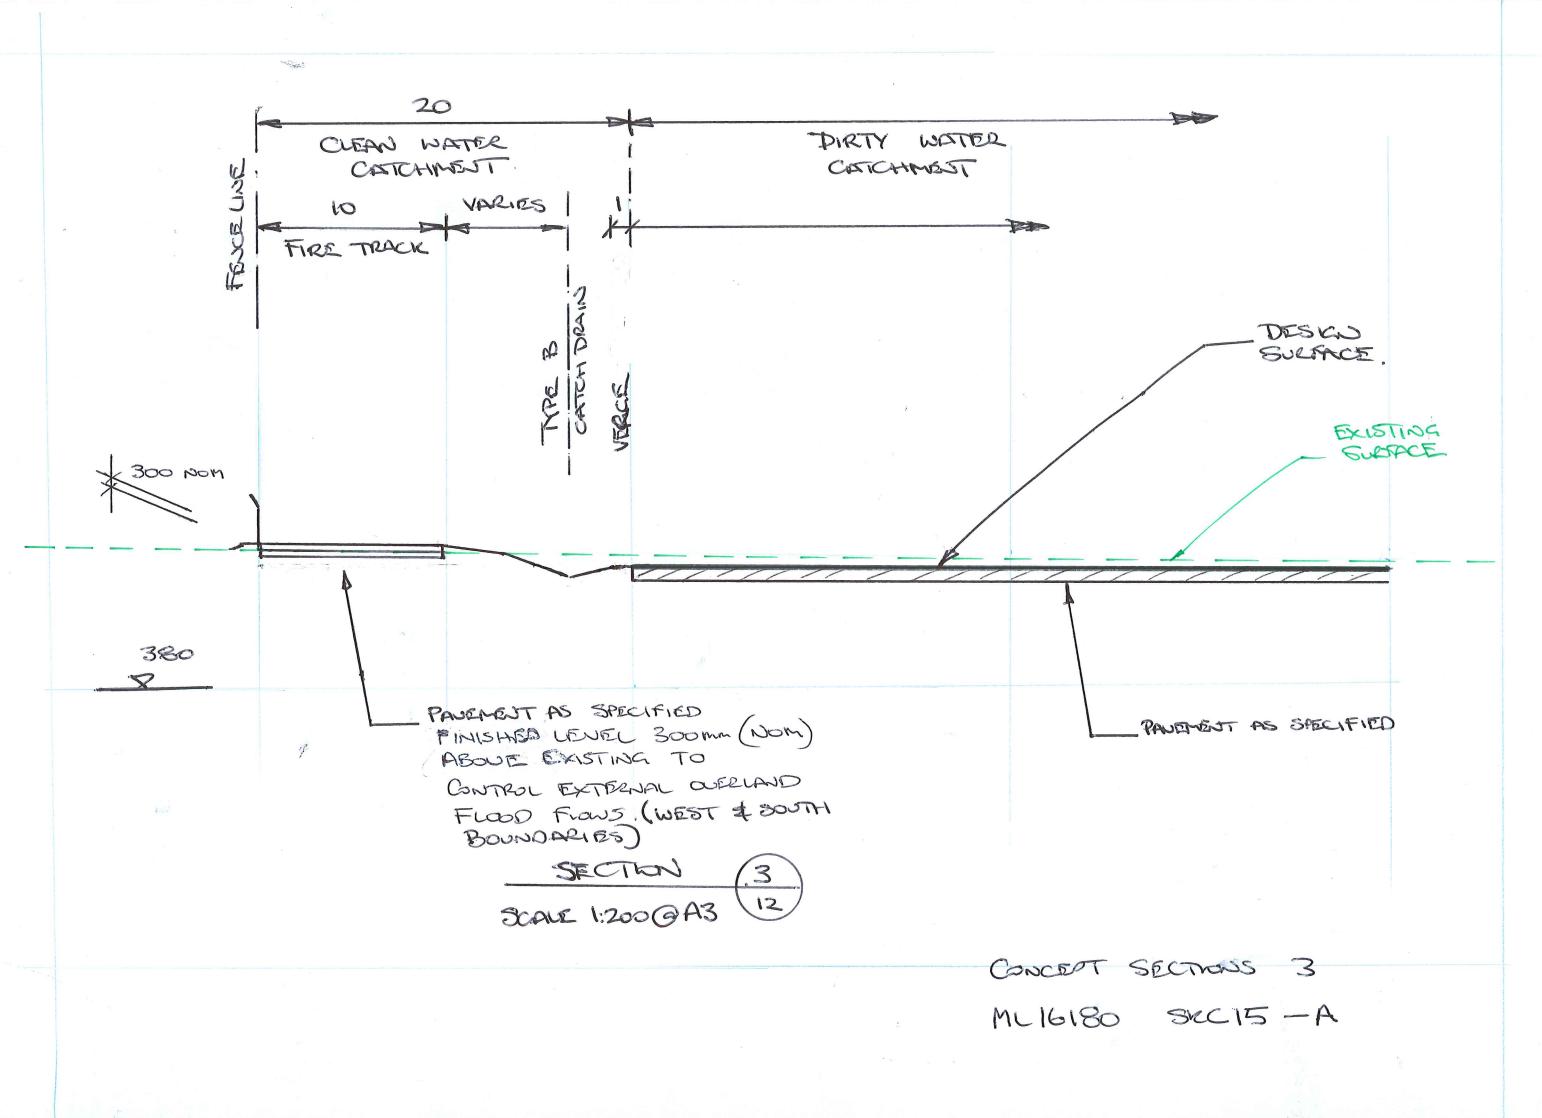

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LITY	DATUMS: DRAWING No.		CLIENT No.		_
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TAMWORTH REGIONAL COUNCIL ORGANIC RECYCLING FACILITY

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DRAWING SCHEDULE

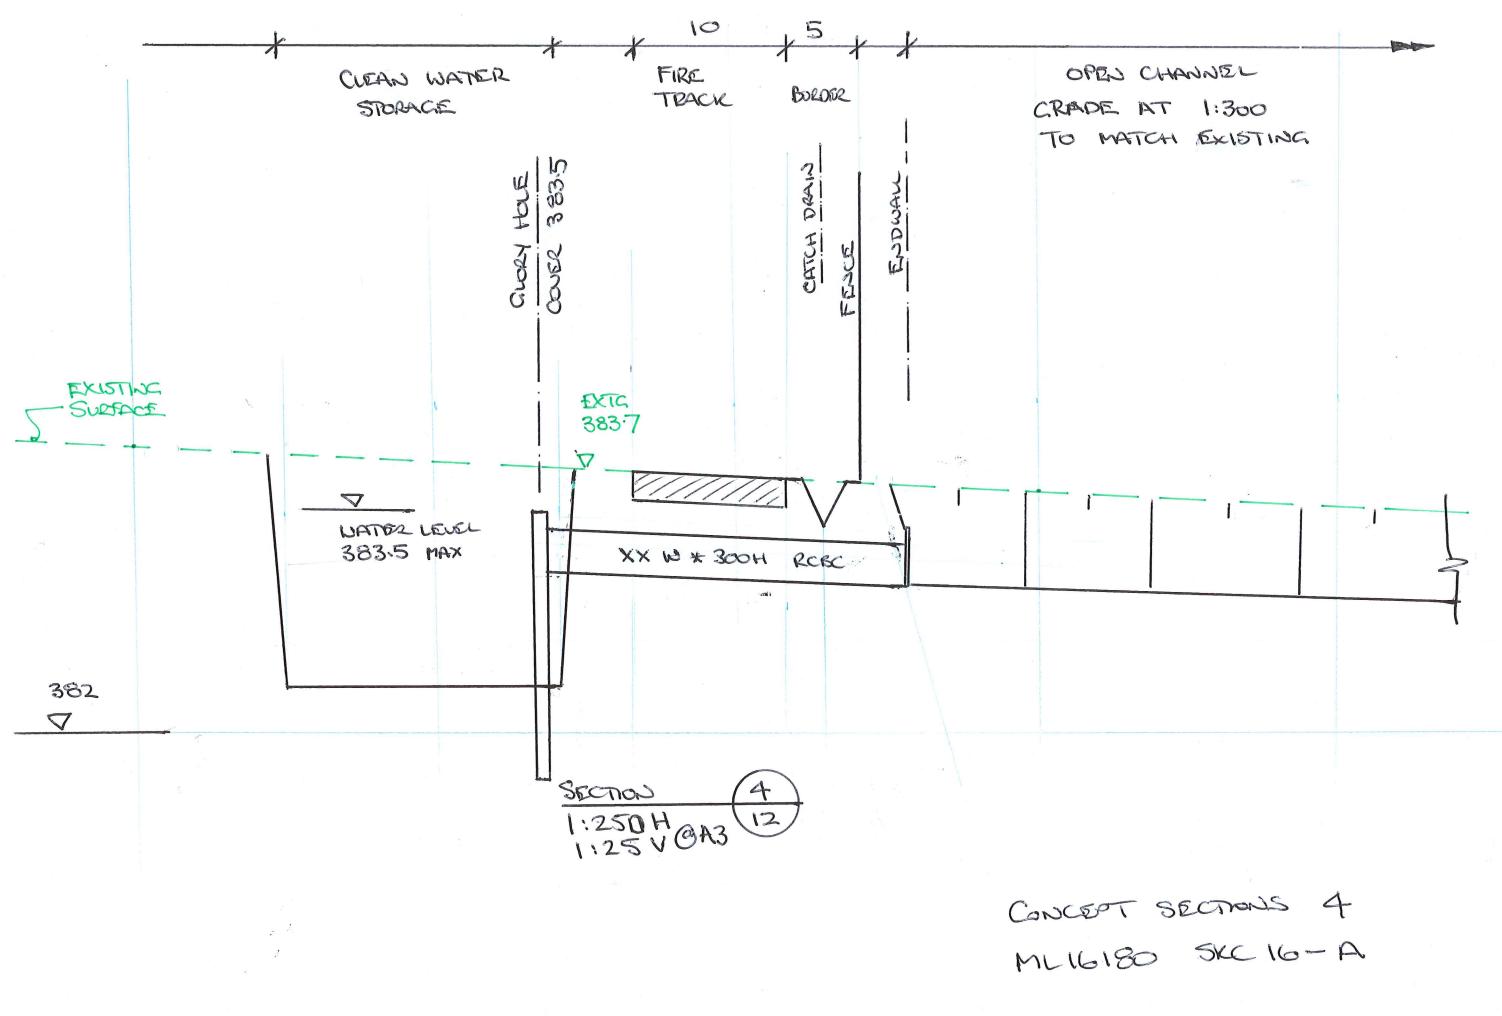ML16026-C002 ML16026-C003	COVER SHEET & DRAWING SCHEDULE COMPUTER FILES & DESIGN CRITERIA KEY PLAN SYMBOLS & GENERAL NOTES
	OPERATIONS PLAN - SHEET 1 OPERATIONS PLAN - SHEET 2
ML16026-C102	CROSS SECTIONS & DETAILS - SHEET 1 CROSS SECTIONS & DETAILS - SHEET 2 CROSS SECTIONS & DETAILS - SHEET 3
YL16026-C202 YL16026-C203 YL16026-C204 YL16026-C205	ALIGNMENT & DRAINAGE PLAN - SHEET 1 ALIGNMENT & DRAINAGE PLAN - SHEET 2 ALIGNMENT & DRAINAGE PLAN - SHEET 3 ALIGNMENT & DRAINAGE PLAN - SHEET 4 ALIGNMENT & DRAINAGE PLAN - SHEET 5 ALIGNMENT & DRAINAGE PLAN - SHEET 6
	DETAIL PLAN - SHEET 1 DETAIL PLAN - SHEET 2
ML16026-C311 ML16026-C321 ML16026-C322 ML16026-C322 ML16026-C323	PAVEMENT PLAN PAVEMENT COMPOSITIONS CONCRETE JOINTING PLAN - SHEET 1 CONCRETE JOINTING PLAN - SHEET 2 CONCRETE JOINTING PLAN - SHEET 3 CONCRETE JOINT DETAILS - SHEET 4
ML16026-C501	SETOUT POINTS
	DRAINAGE PIT SHEDULE DRAINAGE LONGITUDINAL SECTIONS - SHEET 1

						-	0.1515		DRAWING TITLE	
MING REVISION HISTORY DESCRIPTION DRAWN	DESIGNED	REVIEWED	DATE	APPROVED	SCALE 1:5000 SCALE 1:5000	pitt&sherry	CLIENT	TAMWORTH REGIONAL COUNCIL	DRAWING TITLE	
				ORIGINAL COPY ON FILE "e" SIGNED BY		MELBOURNE OFFICE Ph. (03) 9682 5290 HWT Tower 40 Cftv Road Fax. (03) 9682 5292	PROJEC	ORGANIC RECYCLING FACILITY		COVER SHEET & DRAWING SCHEDULE
				-		Southbark www.plisth.com.au Victoria 3006 ABN 67 140 184 309		ORGANIC RECTCLING FACILITY	DATUMS:	CLIENT No.
						© 2010 PITE & SHERRY THIS DOCUMENT IS AND SHALL REMAIN THE PROPERTY OF PITE & SHERRY. THE DOCUMENT MAY ONLY BE USED FOR THE PURPOSE FOR WHICH IT WAS COMMISSIONED AND IN ACCORDING WITH THE TERMS OF ENGAGEMENT FOR THE COMMISSION, UNAUTHORISED USE OF THIS DOCUMENT IN ANY FORM IS PRCHIBITED.	STATUS	PRELIMINARY DESIGN	DRAWING No.	ML16180-C001 REVISION 0

SEMI 25m B-DOUBLE 25m 15.0m RAL 6% 15.0m RAL

×

REFERENCE: AS2890.2-2002

ACCESS DRIVEWAY TABLE 3.2 (FORWARD AND STRAIGHT LINE BACKWARDS) -MAXIMUM GRADE=15.4% CHANGE OF GRADE =MINIMUM K =10/6.25=1.6

SERVICE BAY TURNING AREA SECTION 4.2 MAXIMUM GRADE= 4%

WEIGHBRIDGE INGROUND-ASSUME 0.5% MAXIMUM LONGITUDINAL FALL (FOR INSTRUMENTS) ABOVE GROUND -NO REQUIREMENT(RAMPS VARY TO SUIT)

MINIMUM STRUCTURAL CLEARANCES REFERENCE: AS2890.2-2002 TABLE 4.1 MINIMUM 4.5m

CAR PARK REFERENCE: AS2890.1-2004 BAY LENGHT 5.4m BAY WIDTH 2.4m AISIE WITH 6.2m

DRAWING REVISION HISTORY SHEET SIZE pitt&sherry TAMWORTH REGIONAL COUN A3 DRAWN DESIGNED REVIEWED No. DESCRIPTION DATE APPROVED ORIGINAL COPY ON FILE "e" SIGNED BY MELBOURNE OFFICE Ph. (03) 9682 5290 Fax. (03) 9682 5292 ORGANIC RECYCLING FACIL WT Tower 40 City Road Southbank Victoria 3006 www.plittsh.com.au ABN 67 140 184 30 SIGNED PRELIMINARY DESIGN

KEY CRITERIA FOR DESIGN

VEHICLES

REFERENCE: AUSTROADS DESIGN VEHICLES & TURNING PATH TEMPLATES)

A-DOUBLE 36.2m -ENTER FOWARD -WEIGHED -LOADS AT DISPATCH AREA -ENTER WASHED BAY -WEIGHED -LEAVES FORWARD

SEMI 25m -ENTER FOWARD -WEIGHED -FORWARD TO RAMP -REVERSES UP TO RAMP -TIPS LOAD -WEIGHED -ENTER WASHED BAY -LEAVES FORWARD


DESIGN EMERGENCY FIRE APPLIANCE - 8.8m AUSTROADS RIGID VEHICLE

VERTICAL



DESIGN ML16180-X-SITE BDY

A-DOUBLE 36.2m

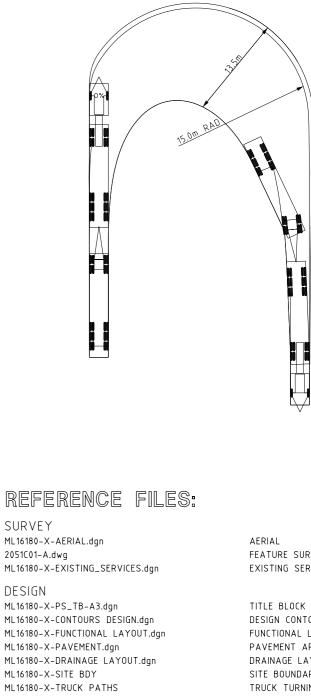


- ML16180-X-SETOUT POINTS.dgn
- DESIGN MODEL
- ML16180-X-EXISTING SURFACE.DTM ML16180-X-DESIGN SURFACE.DTM
- ML16180-X-RECYCLING FACILITY.ALG

FEATURE SURVEY EXISTING SERVICES

DESIGN CONTOURS FUNCTIONAL LAYOUT PAVEMENT AREAS DRAINAGE LAYOUT SITE BOUNDARY TRUCK TURNING PATHS SETOUT POINTS

DIGITAL TERRAIN MODEL DESIGN SURFACE GEOMETRIC FILE

DRAWING TITLE	COMPUTER F	LES						
& DESIGN CRITERIA								
DATUMS:		CLIENT No.						
DRAWING No.	ML16180-C002	REVISION	0					
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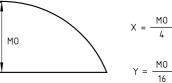
NCIL	DRAWING TITLE						
JTY	KEY PLAN						
	DATUMS:		CLIENT No.				
	DRAWING No.	ML16180-C003	REVISION 0				

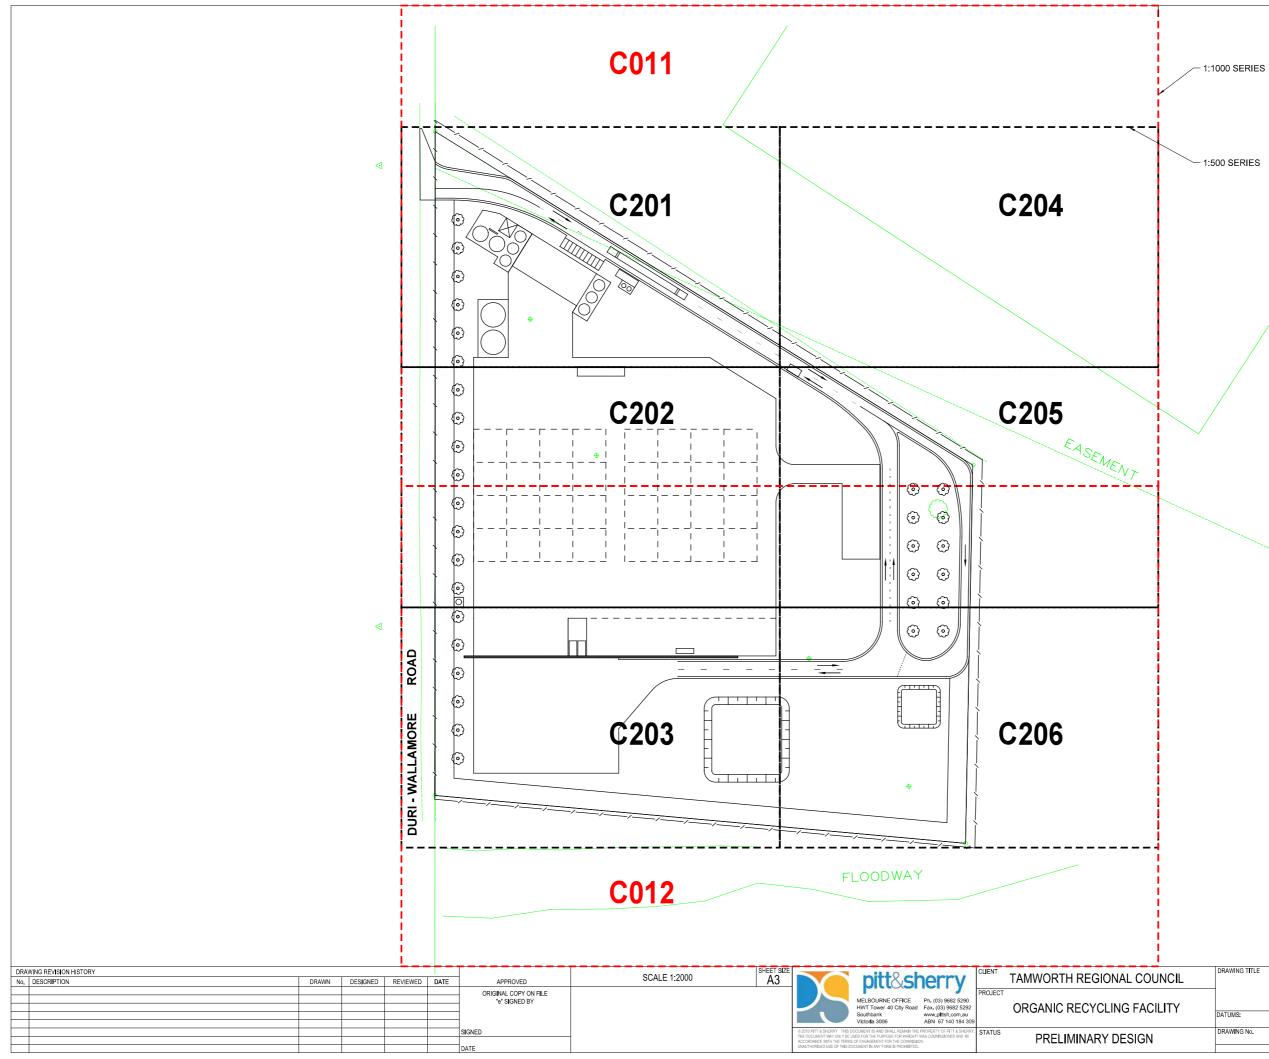EXISTING SERVICES LEGE	END EXISTING DRAINAGE PIT NUMBER EXISTING FIRE HYDRANT DRAIN	SURVEY SYMBOLS REFER SURVEYORS DRAWINGS	NOTES: SETOUT 1. ALL COORDINATES ARE TO A AND REDUCED LEVELS ARE 2. UNLESS NOTED OTHERWISE, ARE TO LIP OF KERB OR FA	TO AHD. SET OUT POINTS
S W T G E	SEWER WATER TELSTRA (UNDERGROUND) GAS ELECTRICITY (UNDERGROUND) ELECTRICITY (OVERHEAD)		CURVE SET-OUT D	$X = \frac{M0}{4}$ $Y = \frac{M0}{16}$
GENERAL LEGEND	KERB AND CHANNEL (SD 2001)		NOTES: DRAINAGE <u>PIPE MATERIALS UNLESS NOTED 0</u> DRAINAGE PIPES 225mm AND LARGER	
BCTA BCTA NJB	BREAKAWAY CABLE TERMINAL (BCTA) REFER SD 3541 AND SD 3571 BREAKAWAY CABLE TERMINAL (BCTB) REFER SD 3542		DRAINAGE PIPES 150mm AND SMALLER SUBSURFACE DRAINS (LONGITUDINAL) SUBSURFACE DRAINS	 - uPVC CLASS SH RRJ - TYPE 3 (SD 1601C) - CATEGORY 1 PIPE WITH FILTER SOCK - CLASS A2 GRANULAR FILTER MATERIAL - TYPE 2 (SD 1601C)
	CONCRETE BARRIER 700mm WIDTH REFER SD 3901D EXISTING SEALED PAVEMENT		(TRANSVERSE AND UNDER ROADS)	- CATEGORY 1 PIPE - NO FINES CONCRETE FILTER MATERIAL
	TYPE K FENCE REFER SD3131 RETAINING WALL			A DOUBLE 36.2m TURNING PATH ENTRY
	DIRTY WATER CATCHMENT			A DOUBLE 36.2m TURNING PATH EGRESS SEMI 25m TURNING PATH


DRAINAGE LEGEND


	DRAIN
12	DRAINAGE PIT & PIT No.
0 ^{S1}	SUBSURFACE DRAINAGE PIT TYPE S1 REFER SD 1611A FOR DETAILS.
•	FLUSHOUT RISER (REFER SD 1631)
	SUBSURFACE DRAIN
—► E —►	CATCH DRAIN AT TOE OF BATTER (SD1531)
\rightarrow \rightarrow	GRASSED CATCH DRAIN - TYPE B (SD1531)
s	SEWER


	AWING REVISION HISTORY	DRAWN	DESIGNED	REVIEWED	DATE	APPROVED	
- H		DIVANIN	DESIGNED	KEVIEWED	DAIL	AFFROVED	
						ORIGINAL COPY ON FILE	PROJECT
						"e" SIGNED BY	MELBOURNE OFFICE Ph. (03) 9682 5290
							HWT Tower 40 Ctty Road Fax. (03) 9882 5292 ORGANIC RECYCLING FACILIT
							Southbank www.pmsn.com.au
						1	Victorita 3006 ABN 67 140 184 309
						SIGNED	© 2010 PTT & SHERRY THIS DOCUMENT IS AND SHALL REMAIN THE PROPERTY OF PTT & SHERRY. STATUS
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					-		UNAUTHORISED USE OF THIS DOCUMENT IN ANY FORM IS PROHIBITED.



ICIL	DRAWING TITLE				
ITΥ		SYMBOLS AND GENERAL NOTES			
••••	DATUMS:		CLIENT No.		
	DRAWING No.	ML16026-C004	REVISION	0	
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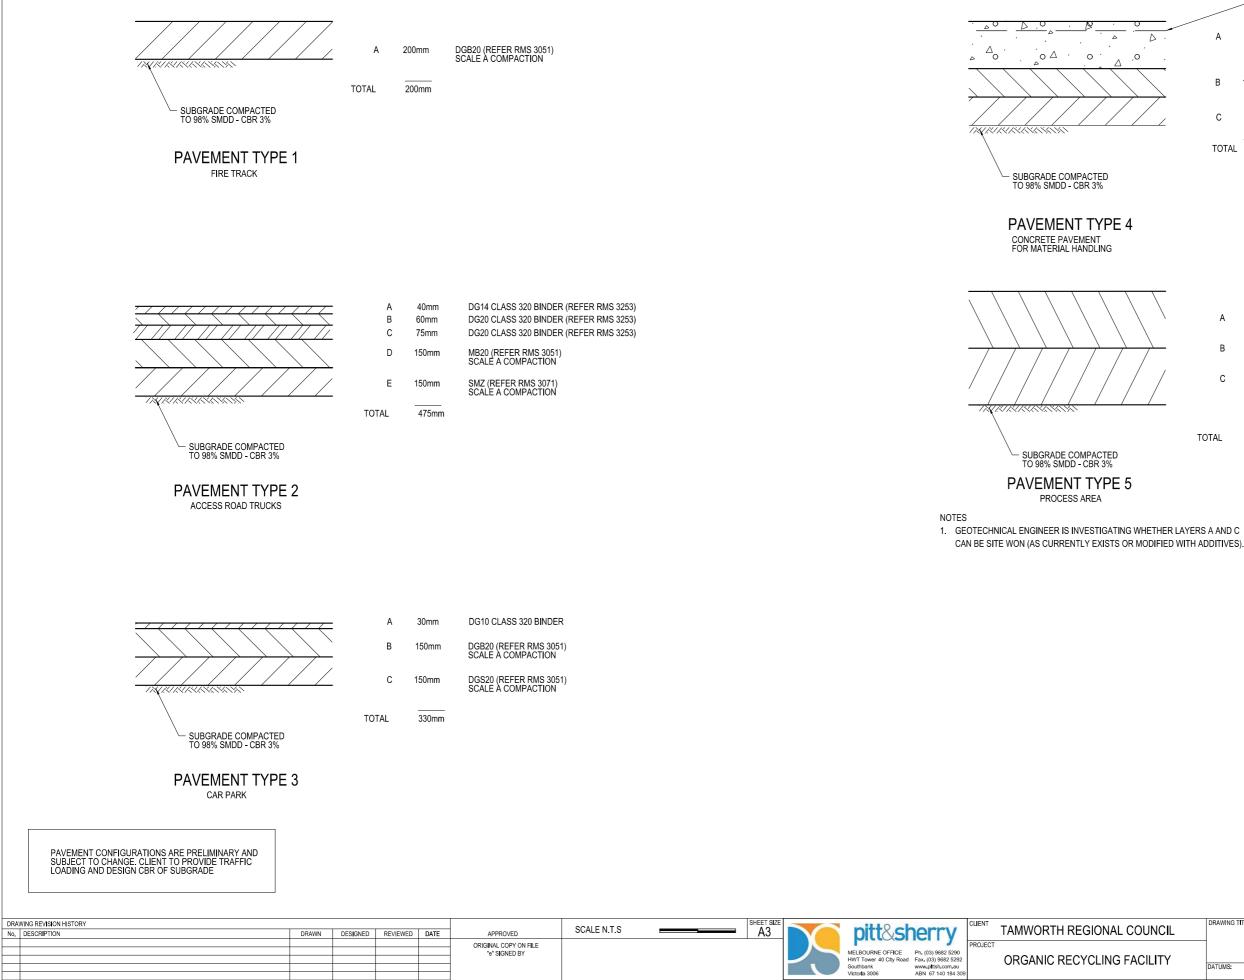


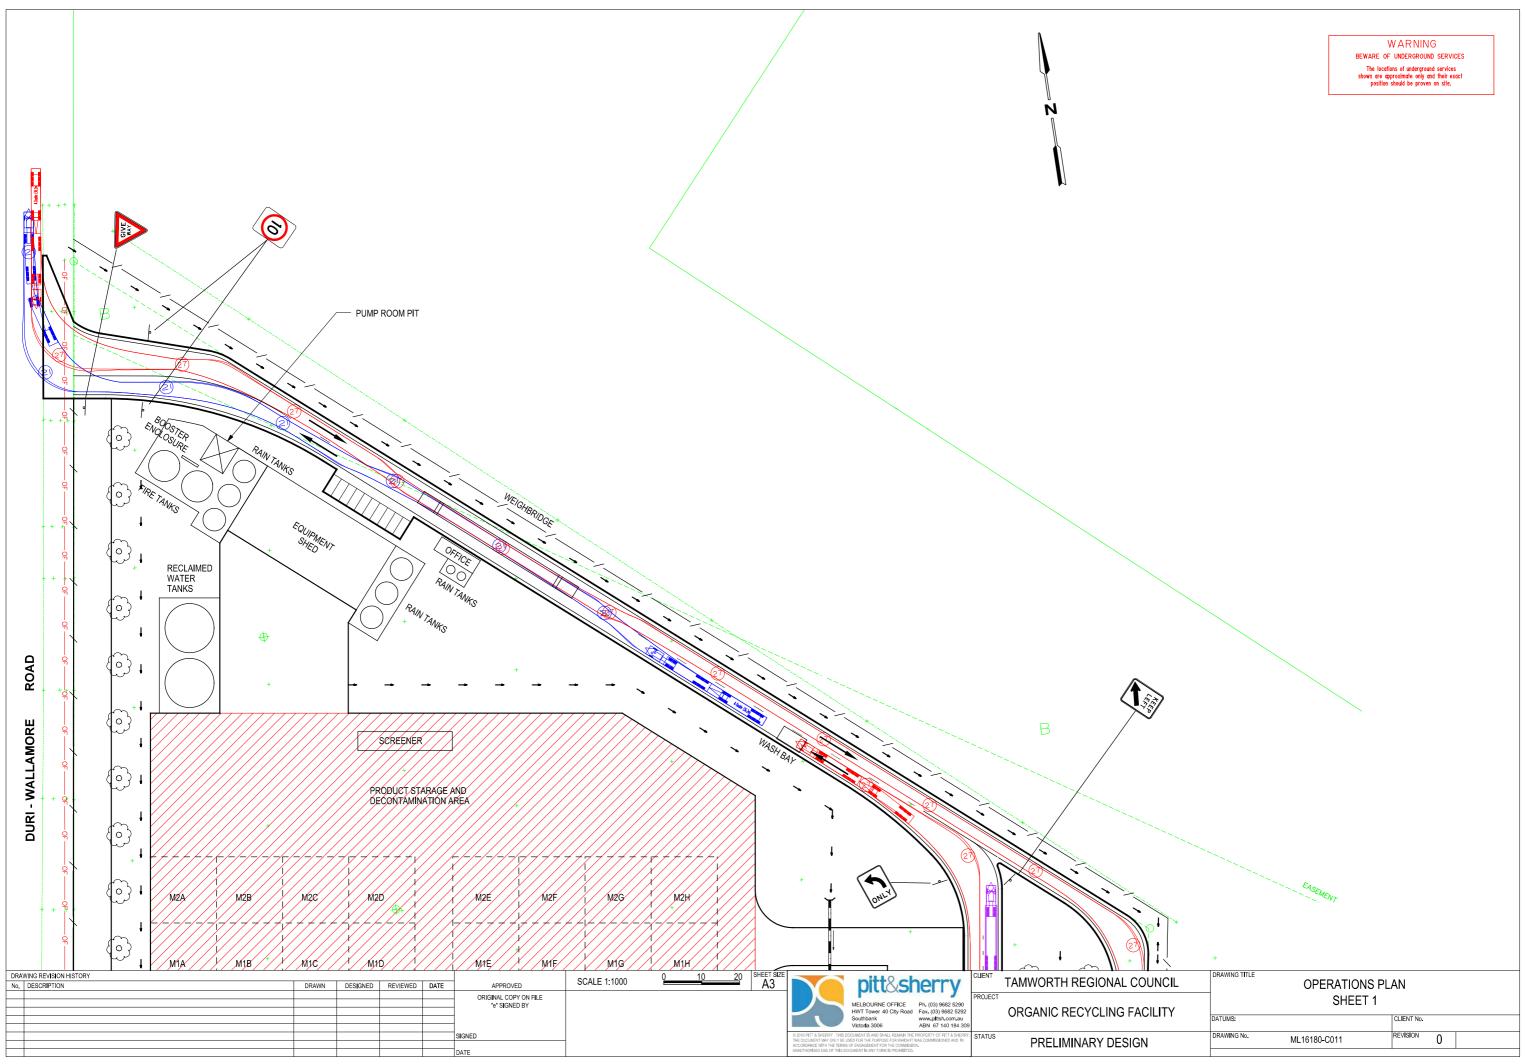

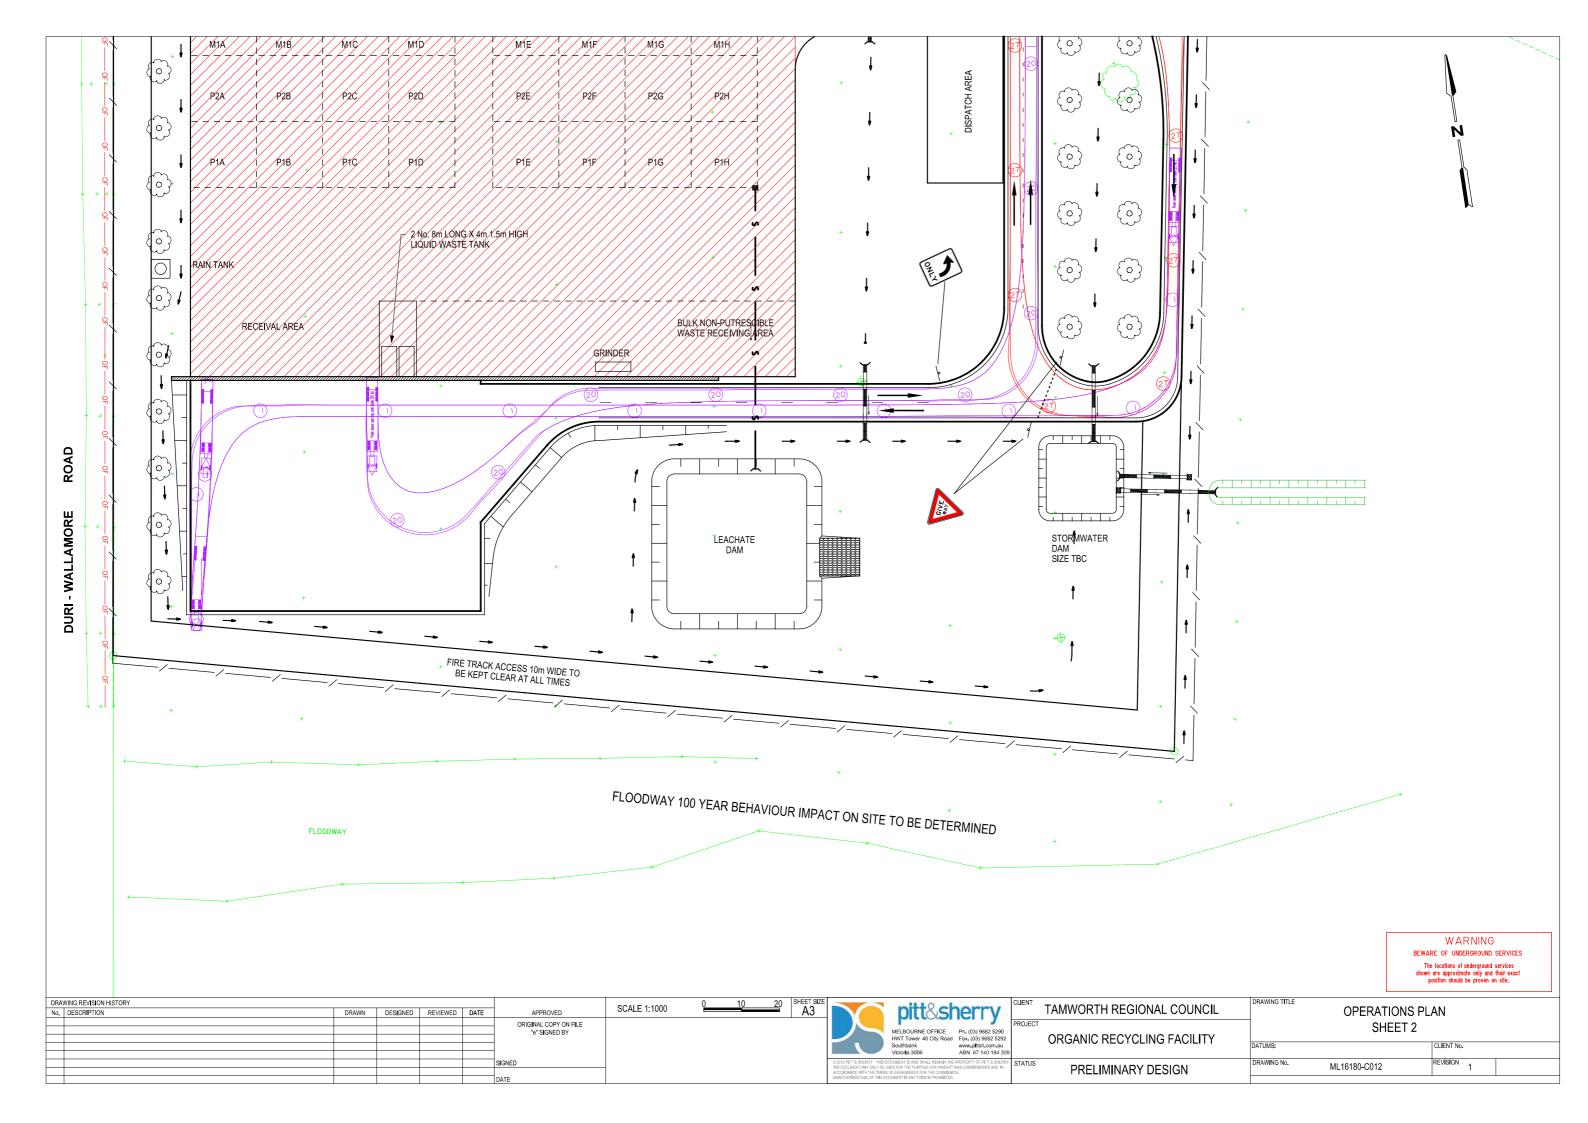

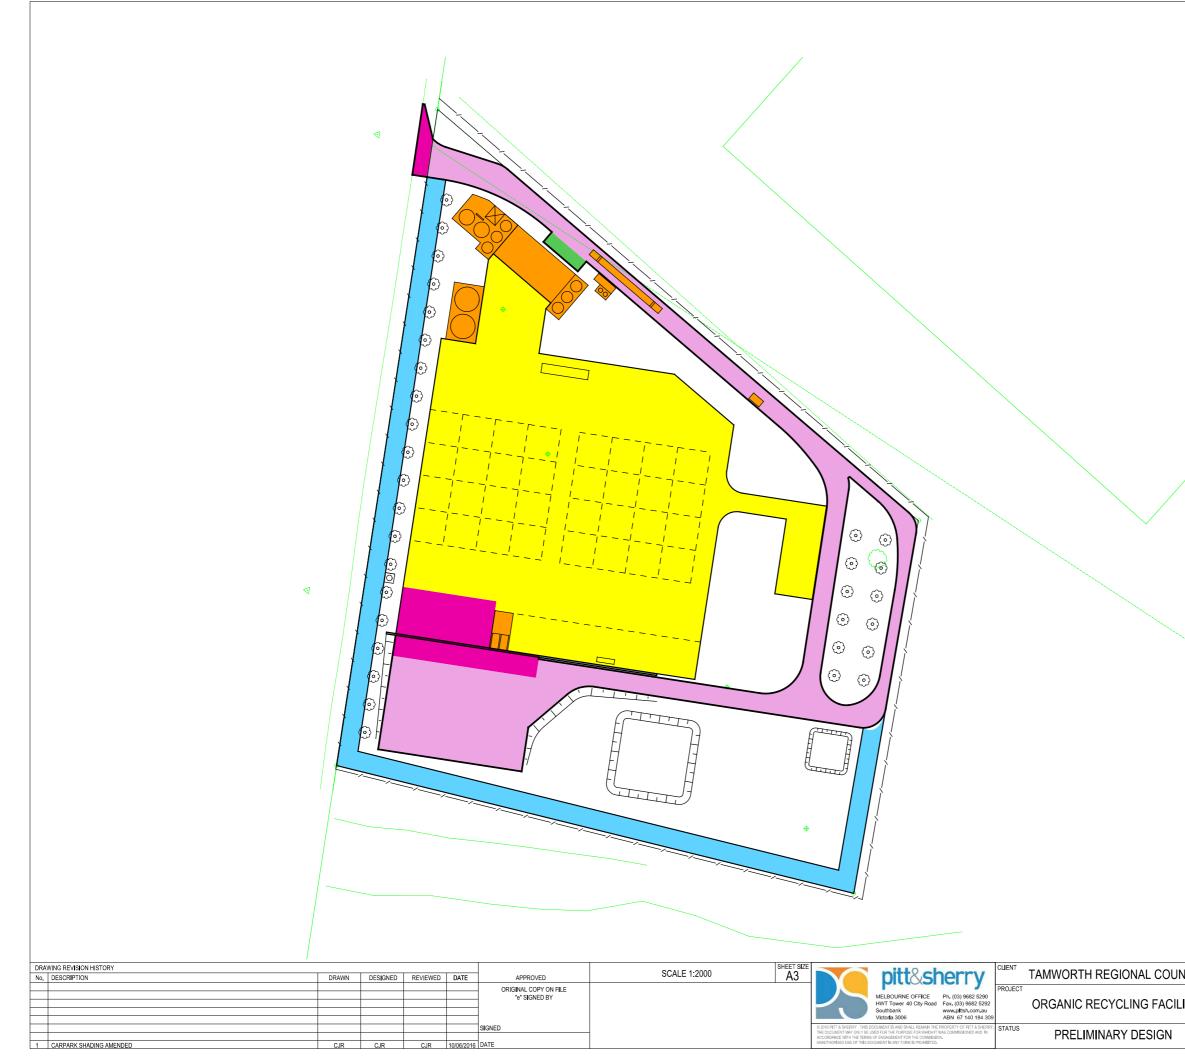PAVEMENT LEGEND	TOTAL m ²
PAVEMENT TYPE 1 FIRE TRACK	6670
PAVEMENT TYPE 2 ACCESS ROAD TRUCKS	11355
PAVEMENT TYPE 3 CAR PARK	165
PAVEMENT TYPE 4 CONCRETE PAVEMENT	2404
PAVEMENT TYPE 5 PROCESS AREA	26173
REFER STRUCTURAL DRAWINGS	

	DRAWING TITLE							
LITY		PAVEMENT PLAN						
	DATUMS:		CLIENT No.					
	DRAWING No.	ML16180-C301	REVISION 1					



SIGNED


PRELIMINARY DESIGN

		M	ESH AS SPECIFIED EFER JOINTING PLANS
Δ .	A	250mm	40MPa CONCRETE. MINIMUM SHRINKAGE STRAIN 450 MICROSTRAIN
	В	150mm	LCS (REFER RMS R82)
	С	150mm	SMZ (REFER RMS 3071) SCALE A COMPACTION
	TOTAL	550mm	
$\overline{\ }$	А	300mm	CLAY. MAXIMUM PERMEABILITY 10 to minus 7
\	В	-	SCALE A COMPACTION SCOUR SURFACE TO PREVENT LAMINATION

CLAY. MAXIMUM PERMEABILITY 10 to minus 7 SCALE A COMPACTION С 300mm

TOTAL 600mm


NCIL	DRAWING TITLE			
ITY		PAVEMENT COMPOSITIONS		
	DATUMS:		CLIENT No.	
	DRAWING No.	ML16180-C311	REVISION 0	

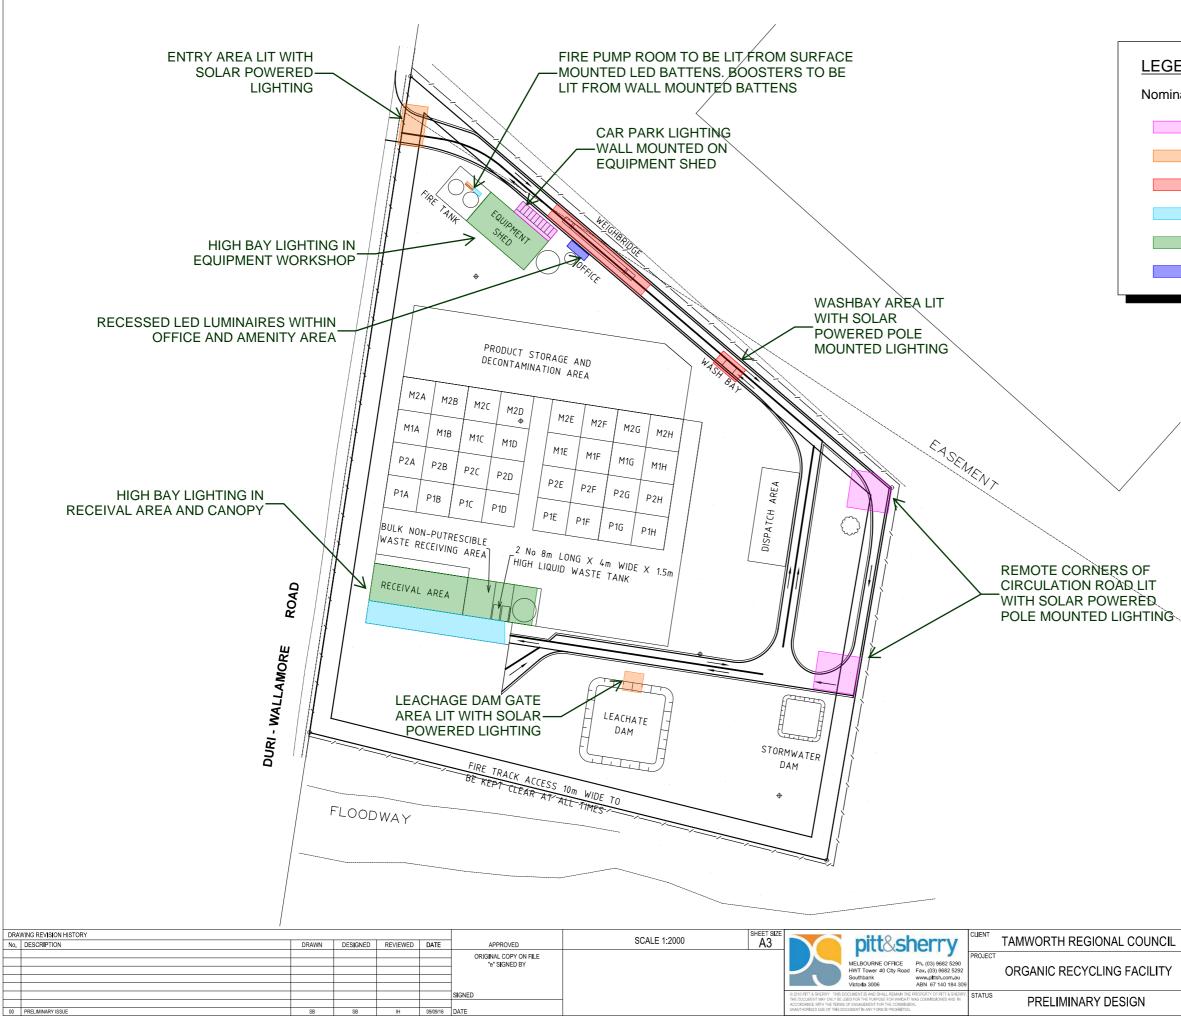

EGEND:				
omina	al average level of illumination			
	3.5 lux			
	10 lux			
	20 lux			
	150 lux			
	240 lux			
	320 lux			

NCIL	DRAWING TITLE	SITE PLAN			
ITY		NOMINAL AVERAGE LIGH	ITING LE	VEL	.S
_111	DATUMS:		CLIENT No.		
	DRAWING No.	ML16180-SK-E-001	REVISION	00	

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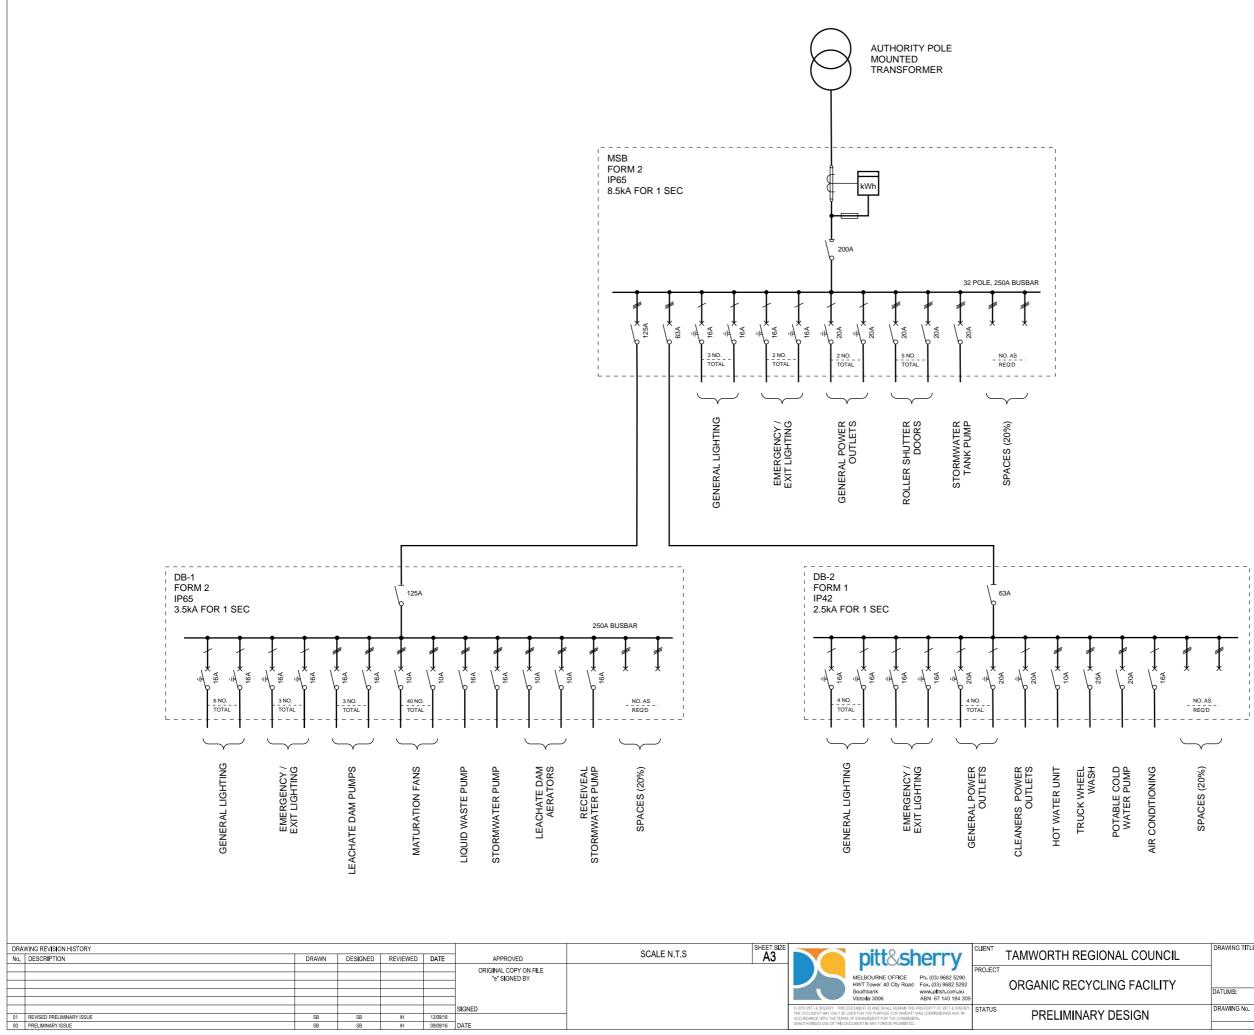


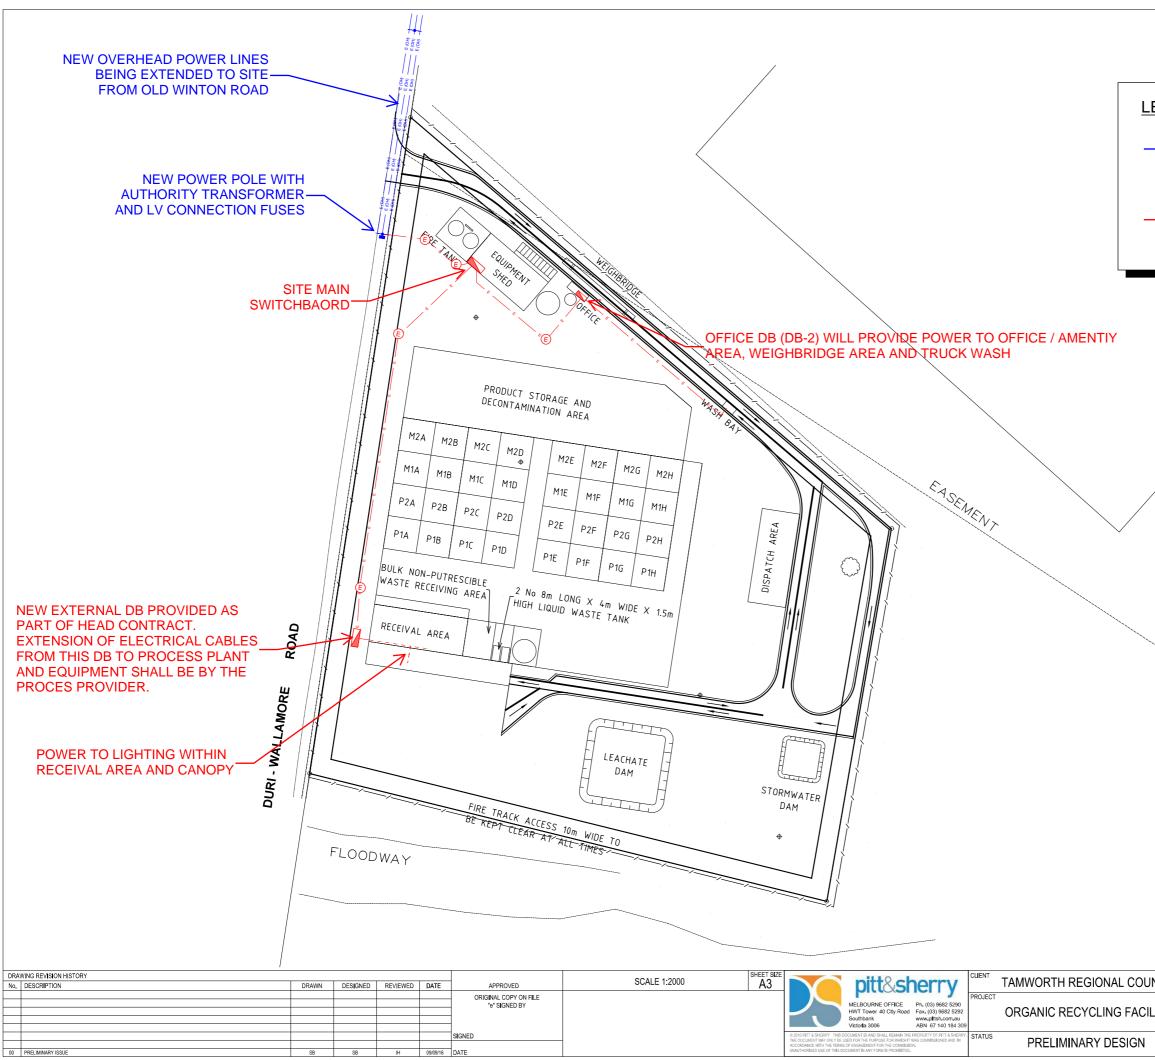LEGEND:


- Works that are part of the utility works package authority
 - Works to be carried out by the contractor as part of the head contract


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ITY	ELECTRICAL DISTRIBU	JTION ARRANGEMENT
	DATUMS:	CLIENT No.
	DRAWING No. ML16180-SK-E-002	REVISION 00


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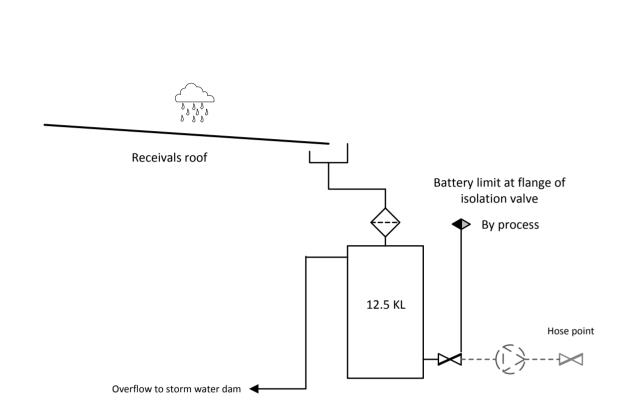


NCIL	DRAWING TITLE	ELECTRICAL SE	RVICES
ITY		ELECTRICAL SCH	EMATICS
	DATUMS:		CLIENT No.
	DRAWING No.	ML16180-SK-E-003	REVISION A




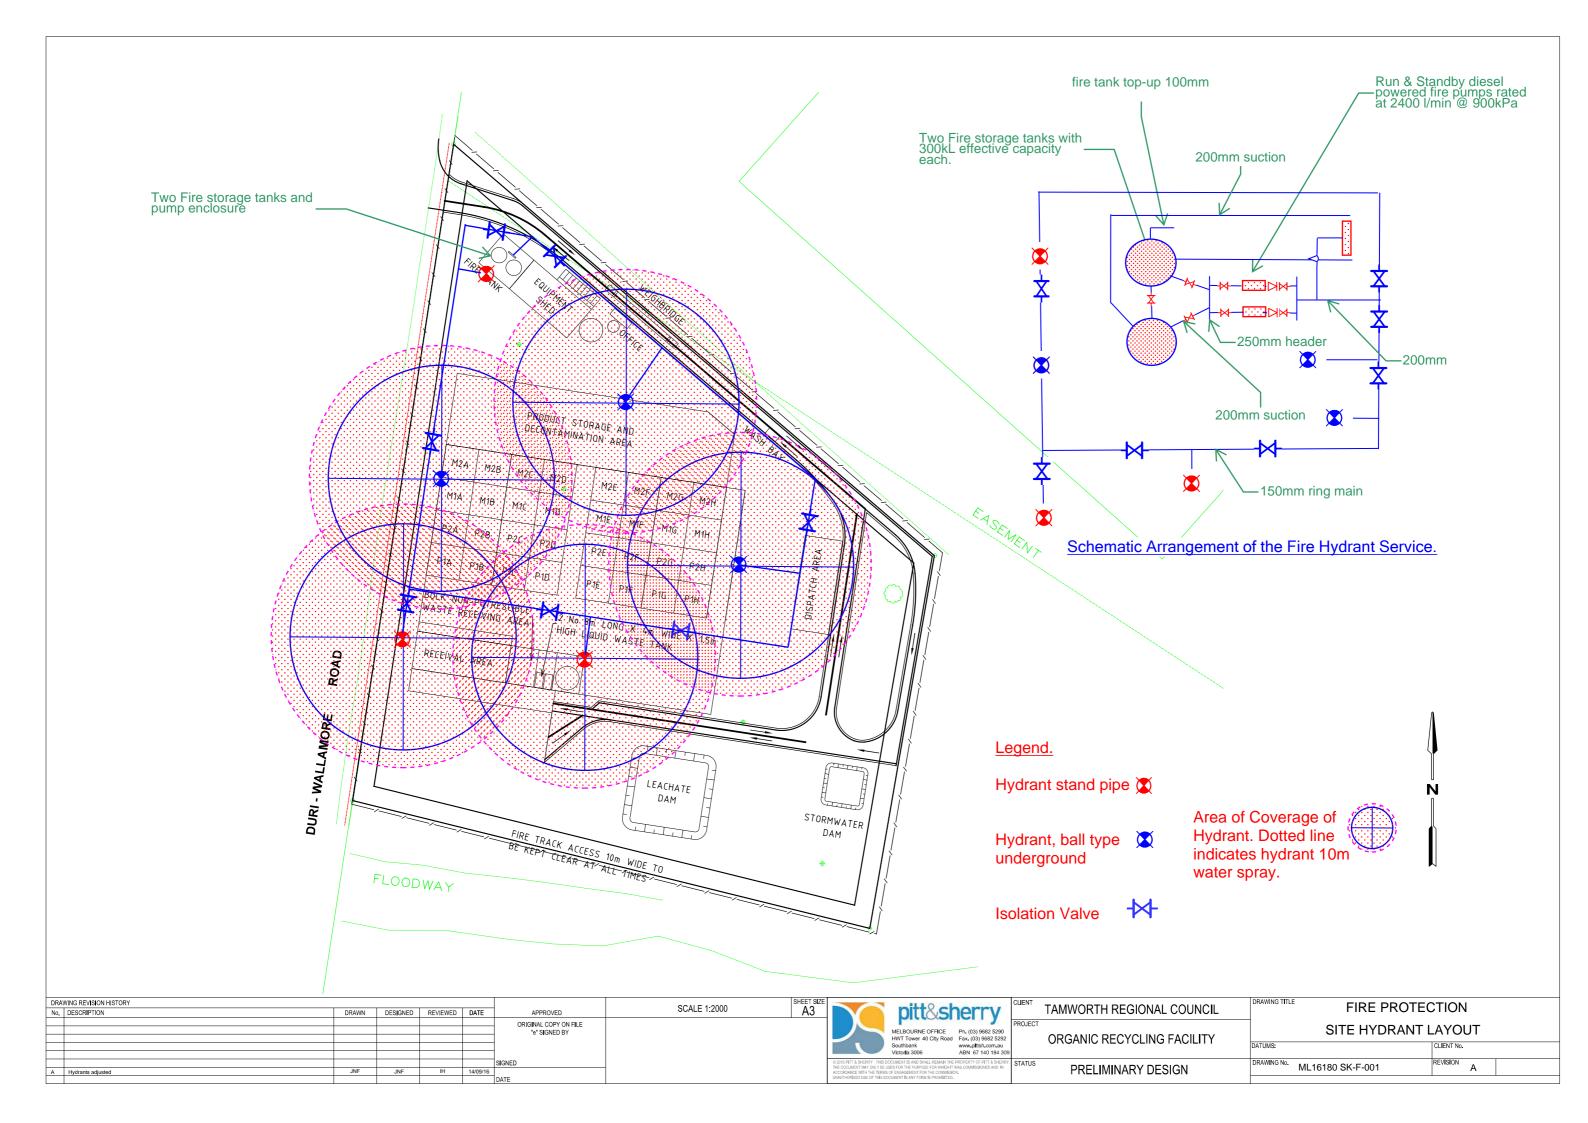

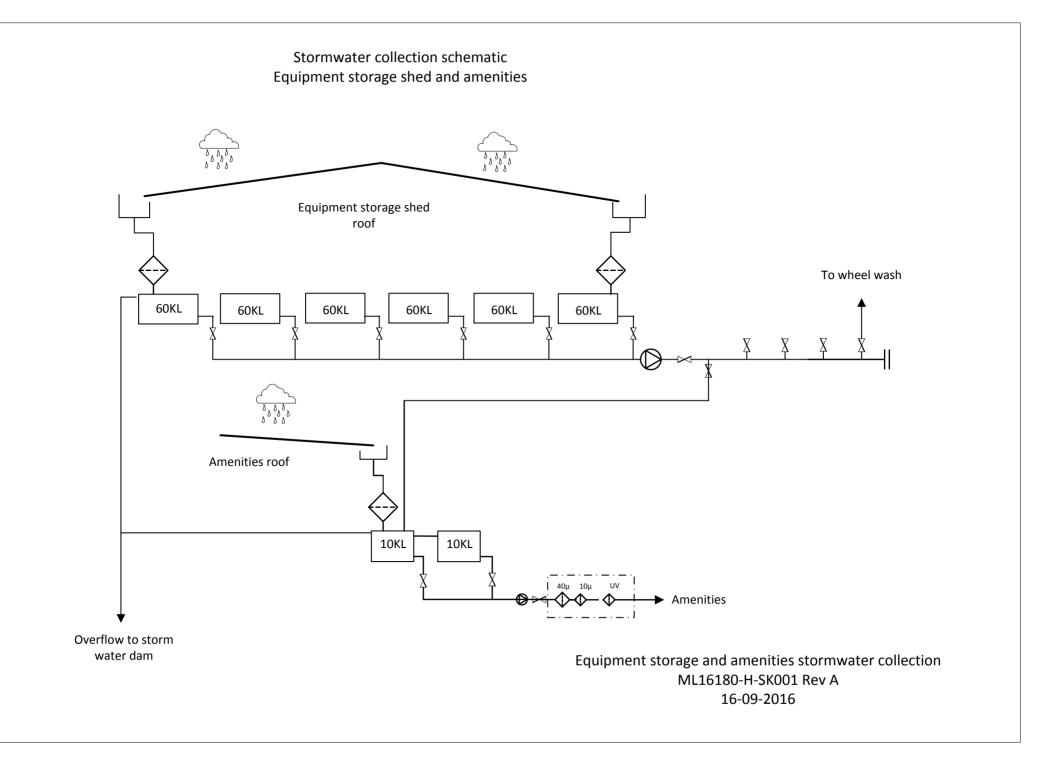

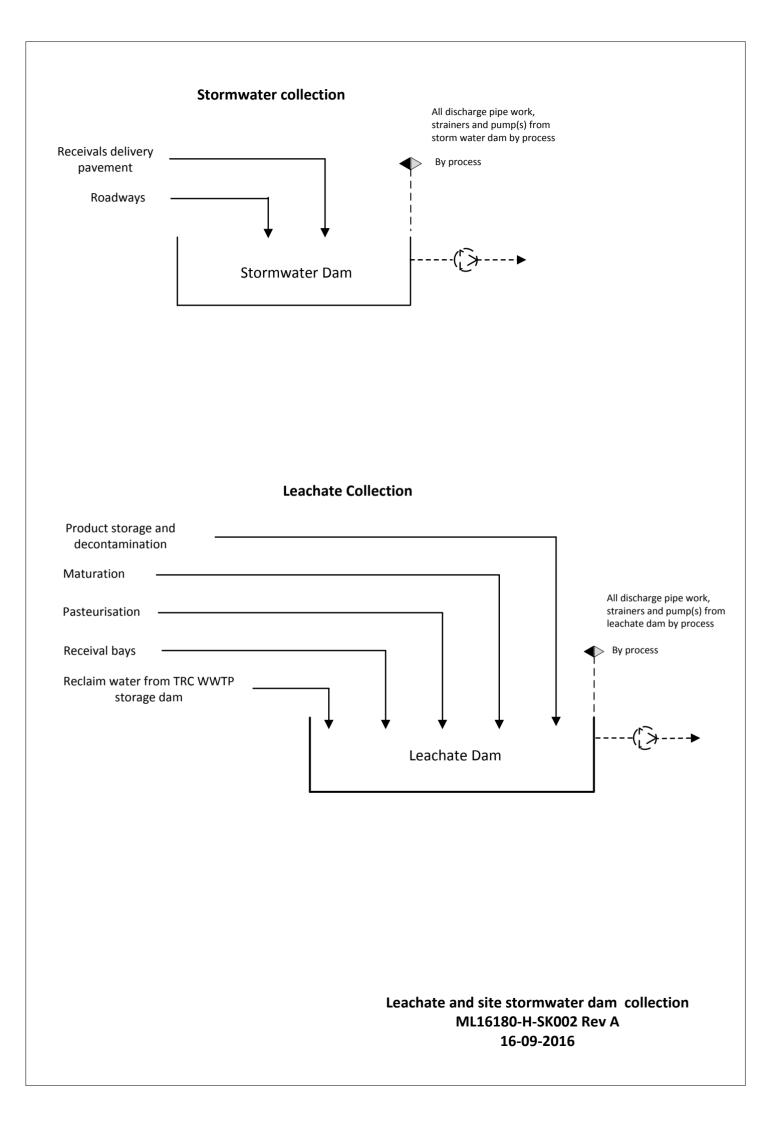

Receivals Stormwater Collection ML16180-H-SK003 Rev A 16-09-2016

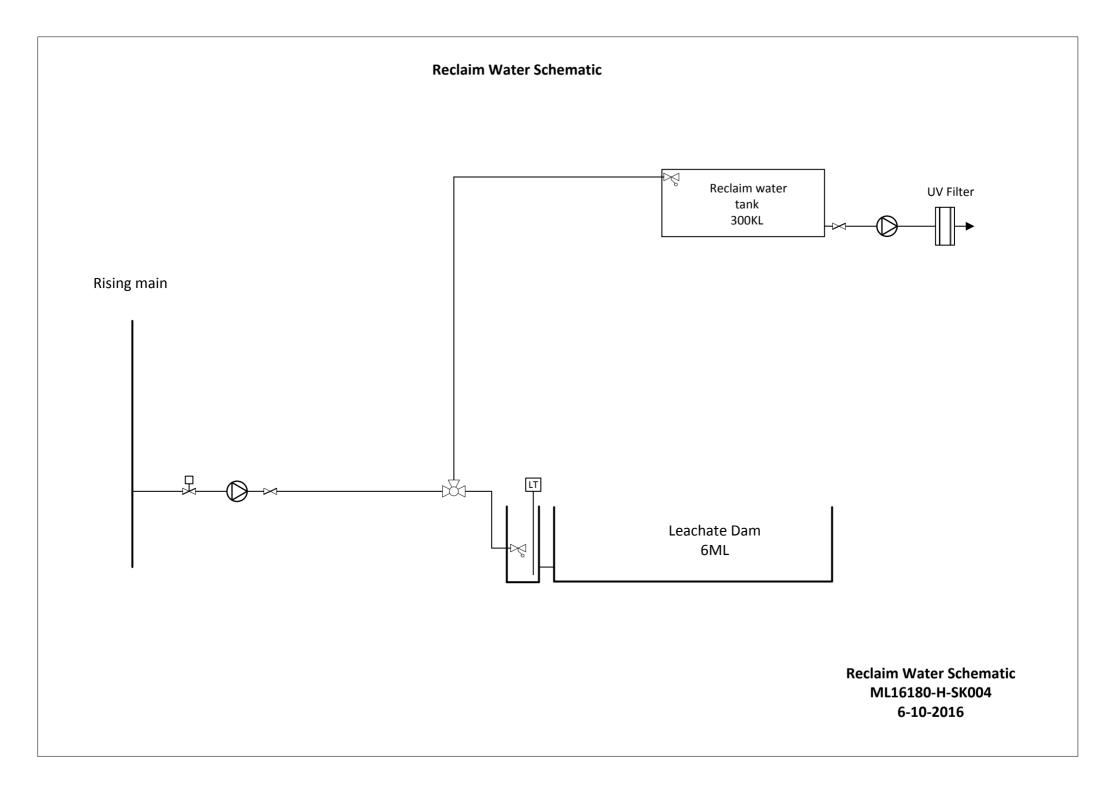


WA	LL LEGEND
7///	CONCRETE BLOCK VENEER WALL WITH A SELECTED RENDER & PAINT FINISH EXTERNALLY & PLASTER LINING INTERNALLY
	13mm NOM. THICK PLASTER BOARD LINED STUD WALL WITH A SELECTED PAINT FINISH
	'STEGBAR' ALUMINIUM FRAMED SLIDING WINDOWS IN A SELECTED POWDER COAT FINISH
	•

FLOOR FINISHES

VIN NON SLIP VINYL FLOOR FINISH CON BROOM FINISHED CONCRETE

FIXTURES LEGEND

REF	UNDER BENCH REFRIGERATOR	HO	COAT HOOK
S	DOUBLE BOWL SINK AND DRAINER	DSH	DDA COMPLIANT SHELF
DW	DISH WASHER	SH	SOAP HOLDER
WB	WASH BASIN	HD	HAND DRYER
WCD	DISABLED TOILET PAN AND CISTERN	MR	MIRROR
HR	HAND / GRAB RAIL	SHR	SHOWER
TPH	TOILET PAPER HOLDER	Τα	1200 X 2700 TABLE
BR	BACK REST	VC	LUNCHROOM CHAIR
CR	CURTAIN RAIL	WS	WORK STATION WITH UPPER COUNTER
ST	SHOWER SEAT	EC	ERGONOMIC CHAIR

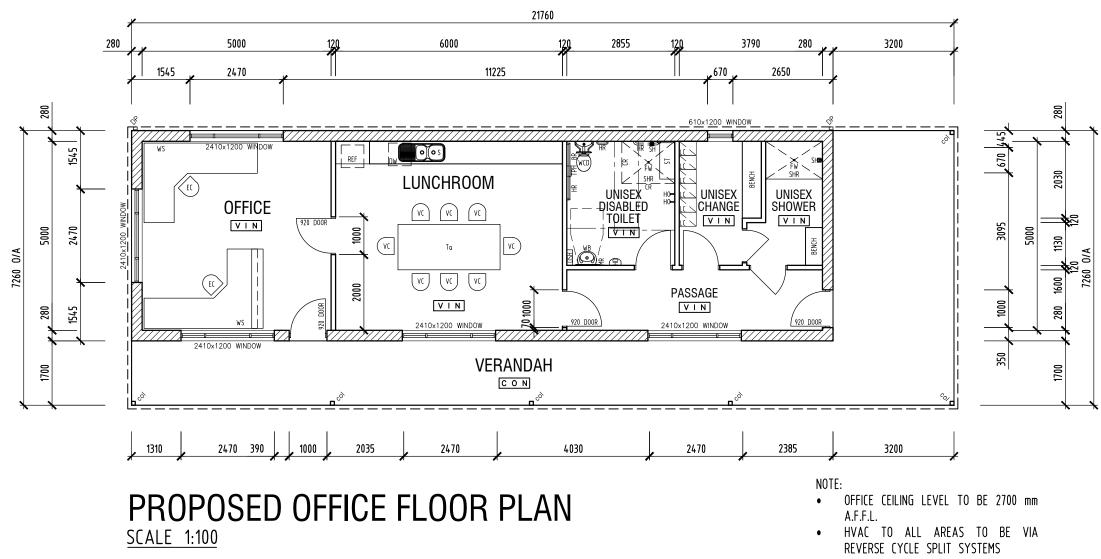

CASTELLUCCI DESIGN GROUP



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PRELIMINARY

16.09.16	D	ADDITIONAL DESK & CHAIR	NH
		ADDED TO OFFICE FLOOR PLAN	
16.09.16	C	VERANDAH EXTENDED BY 1.5M	NH
07.09.16	В	OFFICE WORKSTATION REVISED	MJH
07.09.16	A	OFFICE LAYOUT REVISED	MJH
Date	Rev.	Amendment	Drawn




Client



PROPOSED ORGANIC RECYCLING FACIILITY, TAMWORTH 2340

Drawing Title SCHEMATIC DRAWING: PROPOSED FLOOR PLAN - OFFICE

Cad Reference	Plot Scale	
L\00916\SK\S	1:1@A3	
$\overline{\bigcirc}$	Scale 1:100	Date 06.09.16
\bigcirc	Drawn MJH	Checked NH
Job Number	Drawing No.	Revision
ML16180	SK-A-001	D

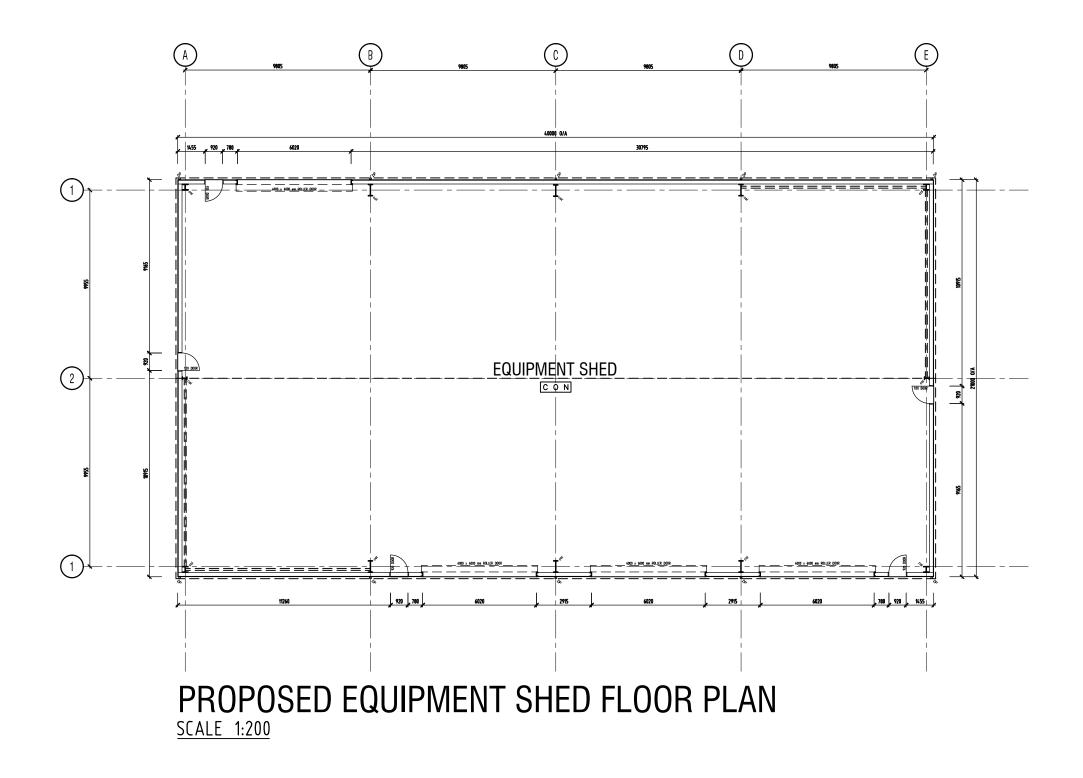

L\00916\SK\S	1:1@A3	
$\overline{\bigcirc}$	Scale 1:200	Date 07.09.16
\bigcirc	Drawn MJH	Checked NH
Job Number ML16180	Drawing No. SK-A-002	Revision

Plot Scale

Drawing Title SCHEMATIC DRAWING: PROPOSED FLOOR PLAN - EQUIPMENT SHED

Cad Reference

Project PROPOSED ORGANIC RECYCLING FACIILITY, TAMWORTH 2340



Client

Rev. Amendmen


	Dav	Amondmont	Drown
Date	Rev.	Amendment	Drawn

PRELIMINARY

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PRELIMINARY

07.10.16	A	CENTRAL BAY ROOF RAISED,	NH
		WALLS ADDED TO END BAYS.	
Date	Rev.	Amendment	Drawn

Client

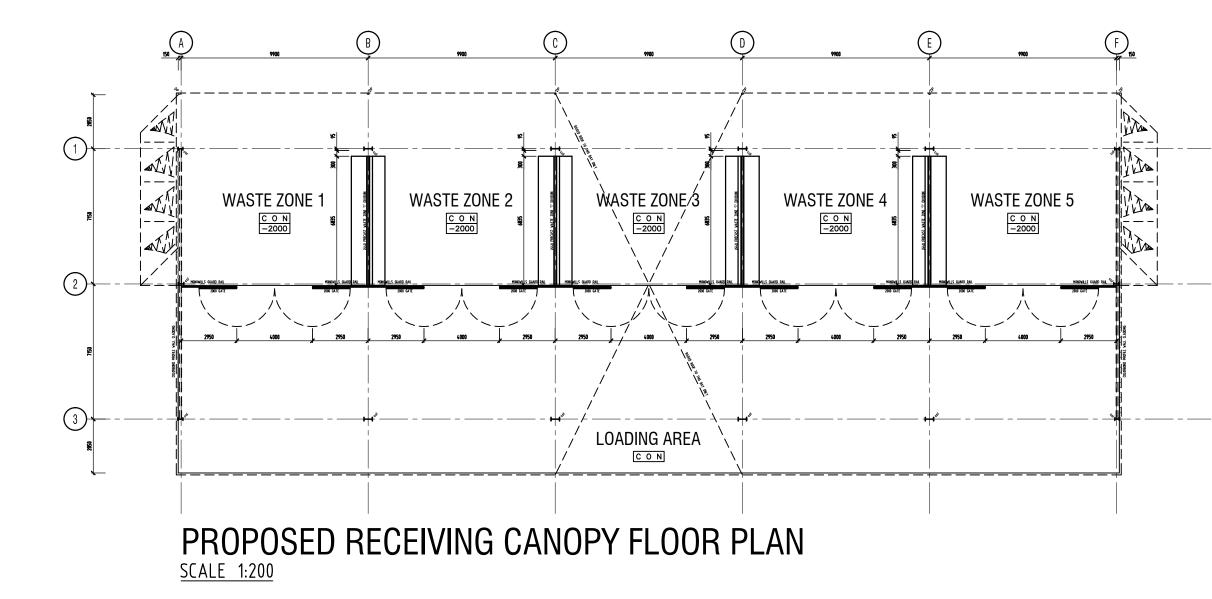

Project PROPOSED ORGANIC RECYCLING FACIILITY, TAMWORTH 2340

Drawing Title SCHEMATIC DRAWING: PROPOSED FLOOR PLAN - RECEIVING CANOPY

Cad Reference	Plot Scale	
L\00916\SK\S	1:1@A3	
$\overline{\bigcirc}$	Scale 1:200	Date 07.09.16
\bigcirc	Drawn MJH	Checked NH
Job Number	Drawing No.	Revision
ML16180	SK-A-003	A



PROPOSED OFFICE 3D PERSPECTIVE 01 NOT TO SCALE



PROPOSED OFFICE 3D PERSPECTIVE 02 NOT TO SCALE

Cad Reference	Plot Scale	
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$\overline{\bigcirc}$	Scale NTS	Date 09.09.16
\bigcirc	Drawn NH	Checked MJH
Job Number	Drawing No.	Revision
ML16180	SK-A-004	B

Drawing Title SCHEMATIC DRAWING: PROPOSED FLOOR PLAN - OFFICE 3D PERSPECTIVES

Project PROPOSED ORGANIC RECYCLING FACIILITY, TAMWORTH 2340



NH

NH

Drawn

Client

16.09.16 ISSUED TO PITT & SHERRY В 16.09.16 Α VERANDAH EXTENDED BY 1M Date Rev. Amendment

PRELIMINARY

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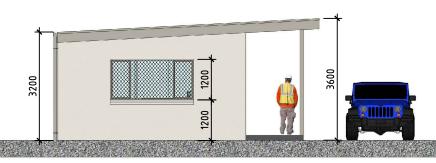
PROPOSED OFFICE ELEVATION 01 NOT TO SCALE



PROPOSED OFFICE ELEVATION 02 NOT TO SCALE



PROPOSED OFFICE ELEVATION 03 NOT TO SCALE



PROPOSED OFFICE ELEVATION 04 NOT TO SCALE

Cad Reference	Plot Scale	
L\00916\SK\SK05.DWG		1:1@A3
	Scale	Date
$\left(\right)$	NTS	09.09.16
	Drawn	Checked
	NH	MJH
Job Number	Drawing No.	Revision
ML16180	SK-A-005	В

Drawing Title SCHEMATIC DRAWING: PROPOSED FLOOR PLAN - OFFICE ELEVATIONS

Project PROPOSED ORGANIC RECYCLING FACIILITY, TAMWORTH 2340



Client

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16.09.16	В	ISSUED TO PITT & SHERRY	NH
16.09.16	Α	VERANDAH EXTENDED BY 1M	NH
Date	Rev.	Amendment	Drawn

PRELIMINARY

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PROPOSED EQUIPMENT SHED 3D PERSPECTIVE 01



PROPOSED EQUIPMENT SHED 3D PERSPECTIVE 02

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PRELIMINARY

16.09.16	В	ISSUED TO PITT & SHERRY	NH
16.09.16	A	OVERALL BUILDING HEIGHT	NH
		REDUCED TO 8M, ROLLER DOOR	
		HEIGHT REDUCED TO 5.5M	
Date	Rev.	Amendment	Drawn

Client



Project

PROPOSED ORGANIC RECYCLING FACIILITY, TAMWORTH 2340

Drawing Title SCHEMATIC DRAWING: PROPOSED FLOOR PLAN - EQUIPMENT SHED 3D PERSPECTIVES


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$\overline{\bigcirc}$	Scale NTS	Date 09.09.16
\bigcirc	Drawn NH	Checked MJH
Job Number	Drawing No.	Revision
ML16180	SK-A-006	B



PROPOSED EQUIPMENT SHED ELEVATION 01



PROPOSED EQUIPMENT SHED ELEVATION 02

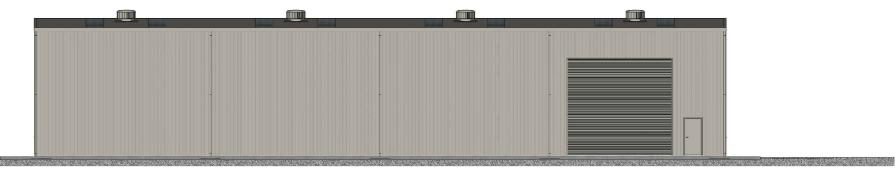

PROPOSED EQUIPMENT SHED ELEVATION 03



NOT TO SCALE

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PRELIMINARY

	1		
16.09.16	В	ISSUED TO PITT & SHERRY	NH
16.09.16	A	OVERALL BUILDING HEIGHT	NH
		REDUCED TO 8M, ROLLER DOOR	
		HEIGHT REDUCED TO 5.5M	
Date	Rev.	Amendment	Drawn

Client



Project

PROPOSED ORGANIC RECYCLING FACIILITY, TAMWORTH 2340

Drawing Title SCHEMATIC DRAWING: PROPOSED FLOOR PLAN - EQUIPMENT SHED ELEVATIONS

Cad Reference	Plot Scale	
L\00916\SK\S	1:1@A3	
$\overline{\bigcirc}$	Scale NTS	Date 09.09.16
\bigcirc	Drawn NH	Checked MJH
Job Number	Drawing No.	Revision
ML16180	SK-A-007	B



PROPOSED RECEIVING CANOPY 3D PERSPECTIVE 01 NOT TO SCALE



PROPOSED RECEIVING CANOPY 3D PERSPECTIVE 02 NOT TO SCALE

CASTELLUCCI DESIGN GROUP



Castellucci Design Group Pty Ltd Architects ABN 56076742231

Level 8, 50 Queen Street, Melbourne Vic 3000 Telephone 03 9629 6766 Facsimile 03 9629 9744 Email Castellucci_D_G@bigpond.com

PRELIMINARY

	1		
07.10.16	A	CENTRAL BAY ROOF RAISED,	NH
		WALLS ADDED TO END BAYS.	
Date	Rev.	Amendment	Drawn

Client




Project

PROPOSED ORGANIC RECYCLING FACIILITY, TAMWORTH 2340

Drawing Title SCHEMATIC DRAWING: PROPOSED FLOOR PLAN - RECEIVING CANOPY **3D PERSPECTIVES**

Cad Reference	Plot Scale	
L\00916\SK\S	1:1@A3	
$\overline{\bigcirc}$	Scale NTS	Date 09.09.16
\bigcirc	Drawn NH	Checked MJH
Job Number	Drawing No.	Revision
ML16180	SK-A-008	A

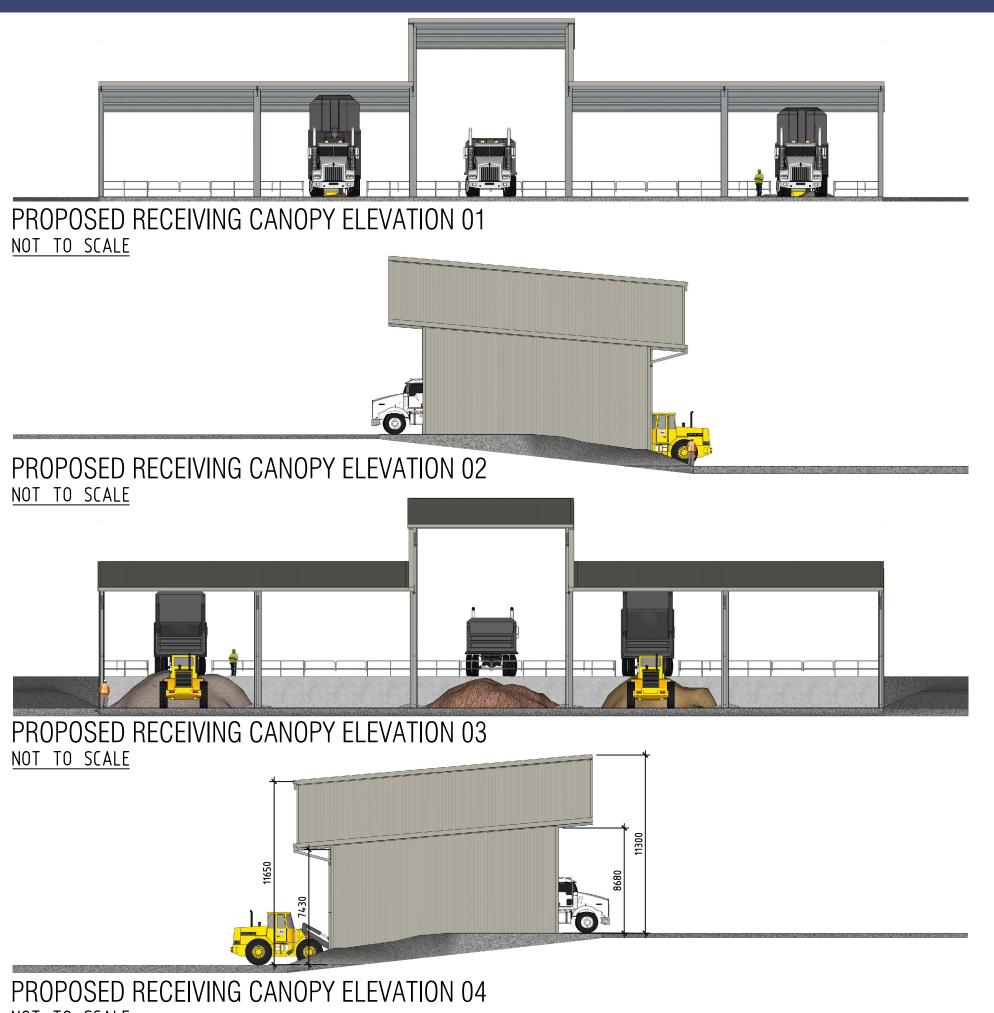

NOT TO SCALE

CASTELLUCCI DESIGN GROUP



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PRELIMINARY

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Date	Rev.	Amendment	Drawn

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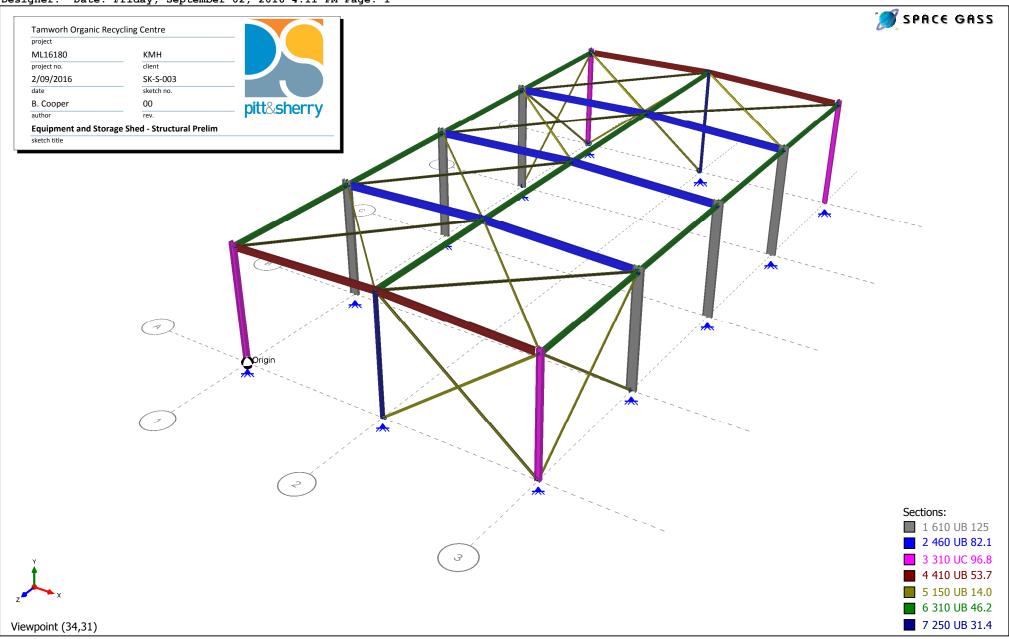



Project PROPOSED ORGANIC RECYCLING FACIILITY, TAMWORTH 2340


Drawing Title SCHEMATIC DRAWING: PROPOSED FLOOR PLAN - RECEIVING CANOPY ELEVATIONS

Cad Reference	Plot Scale	
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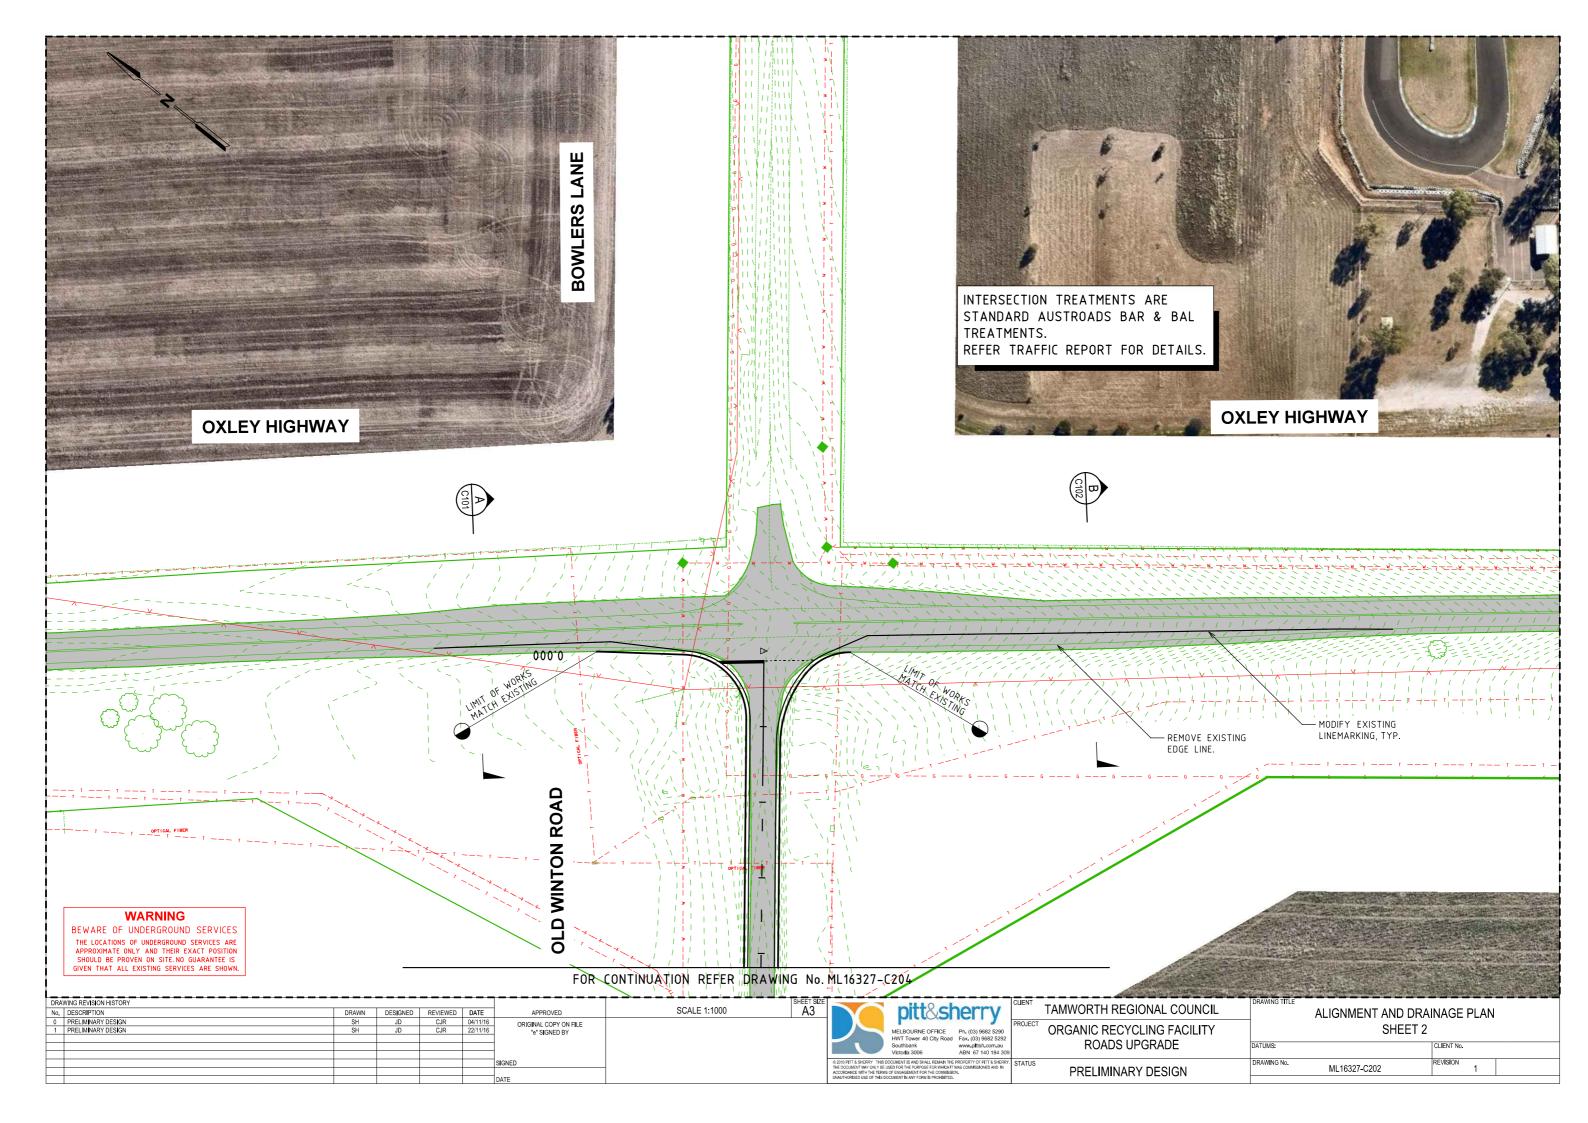





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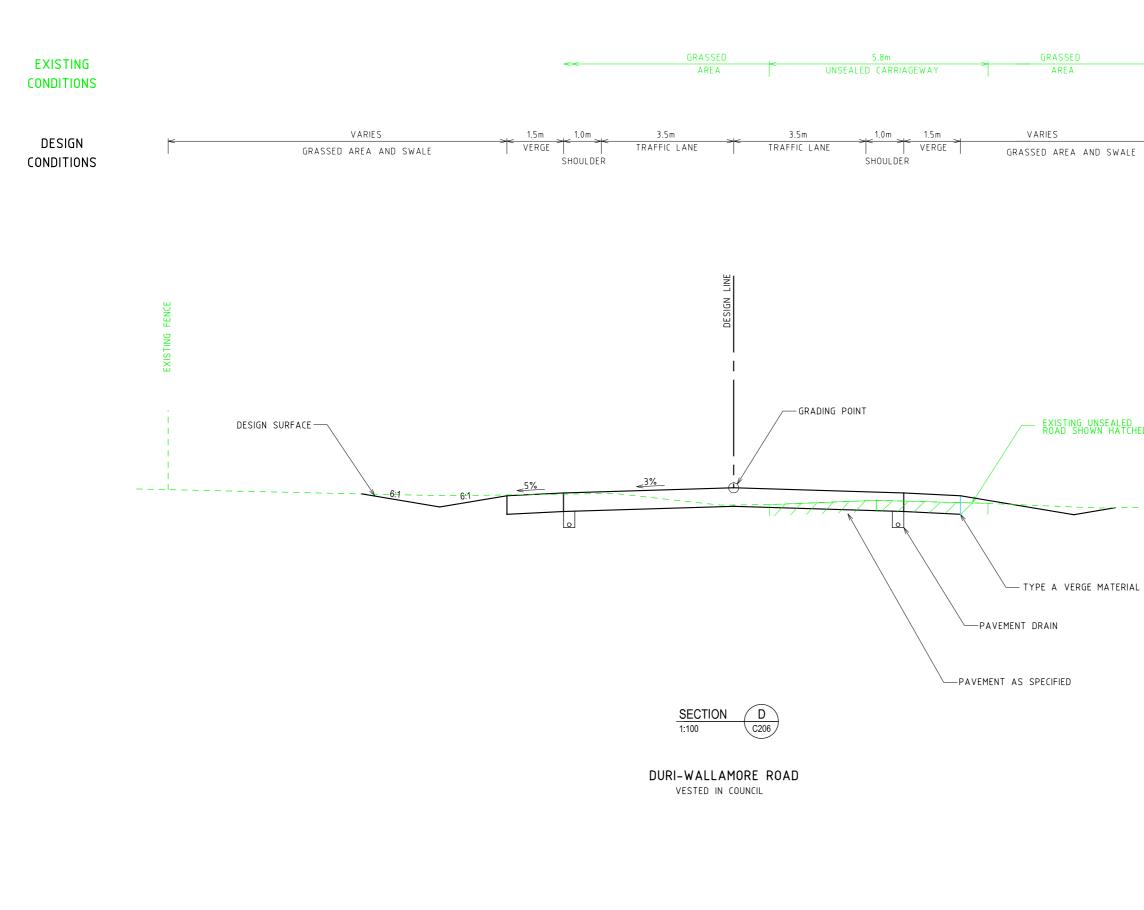
BEWARE OF UNDERGROUND SERVICES THE LOCATIONS OF UNDERGROUND SERVICES ARE APPROXIMATE ONLY AND THEIR EXACT POSITION SHOULD BE PROVEN ON SITE. NO GUARANTEE IS GIVEN THAT ALL EXISTING SERVICES ARE SHOWN.
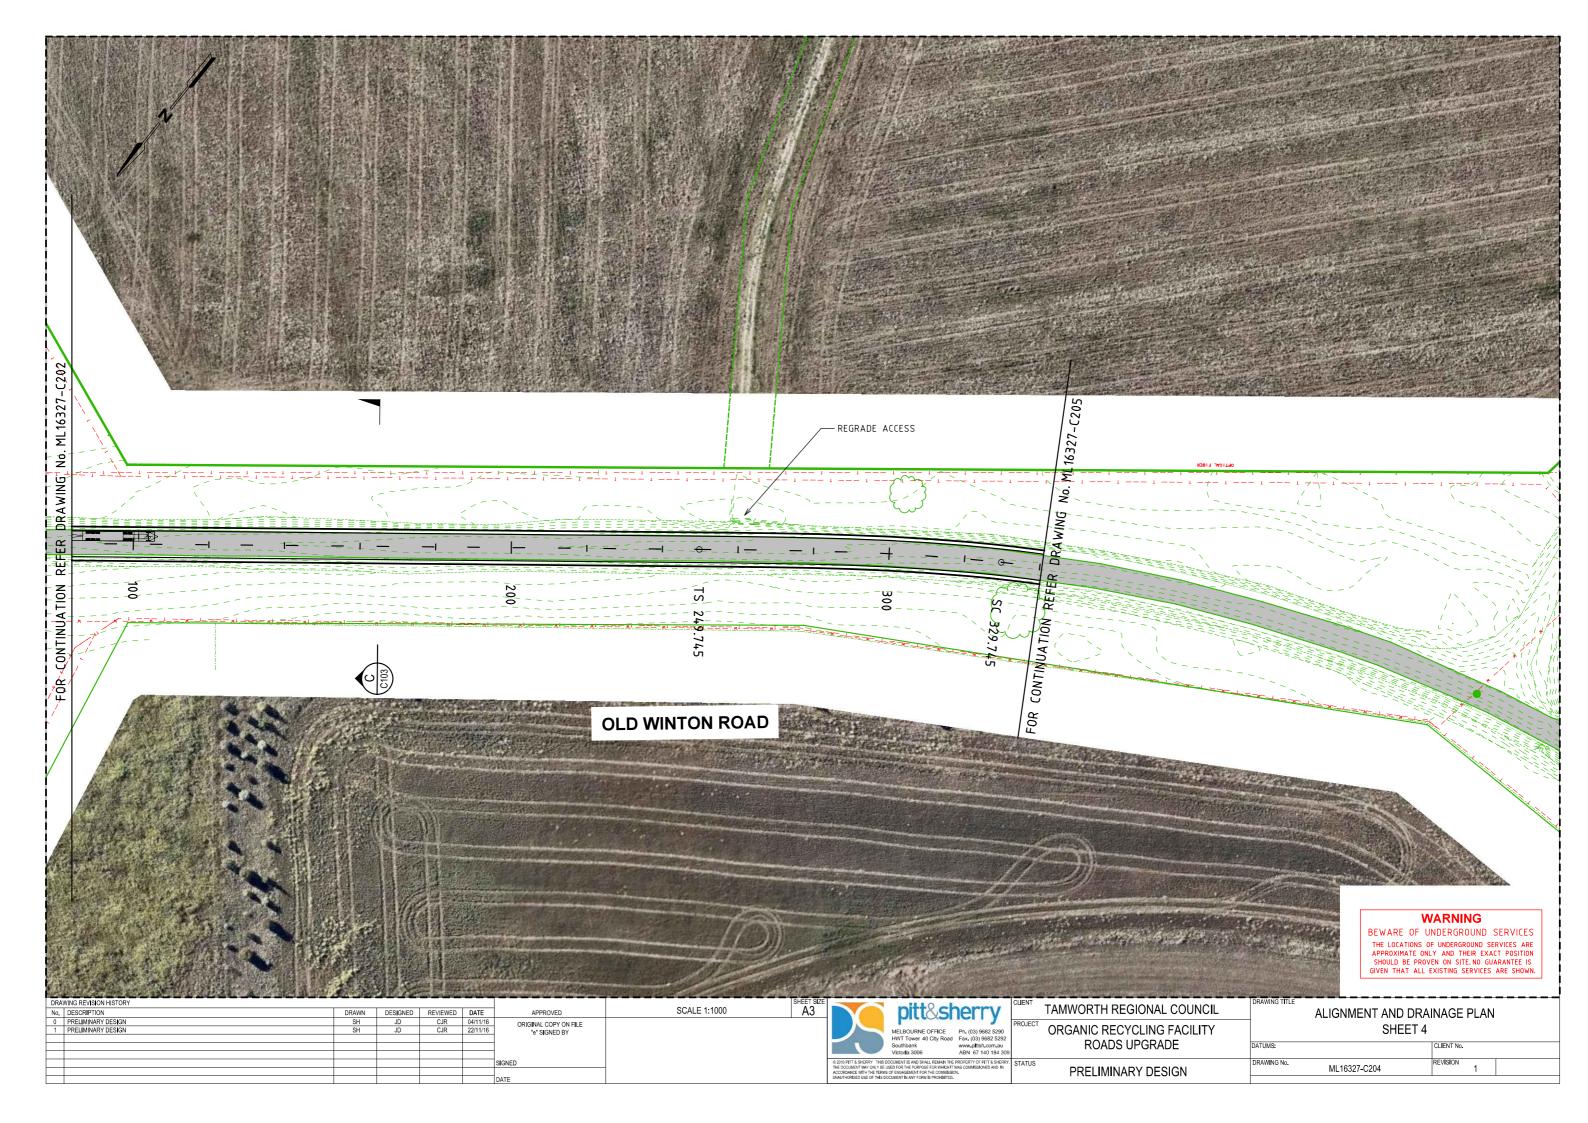
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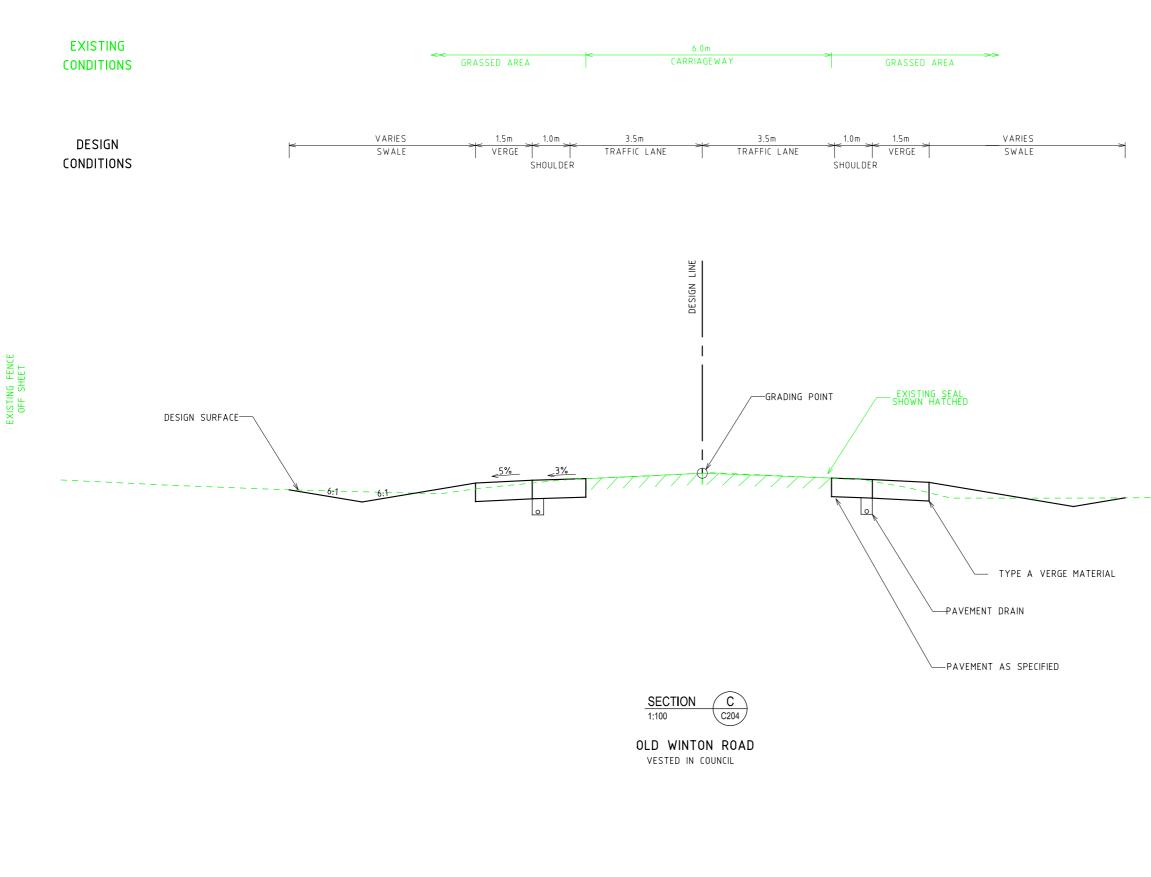


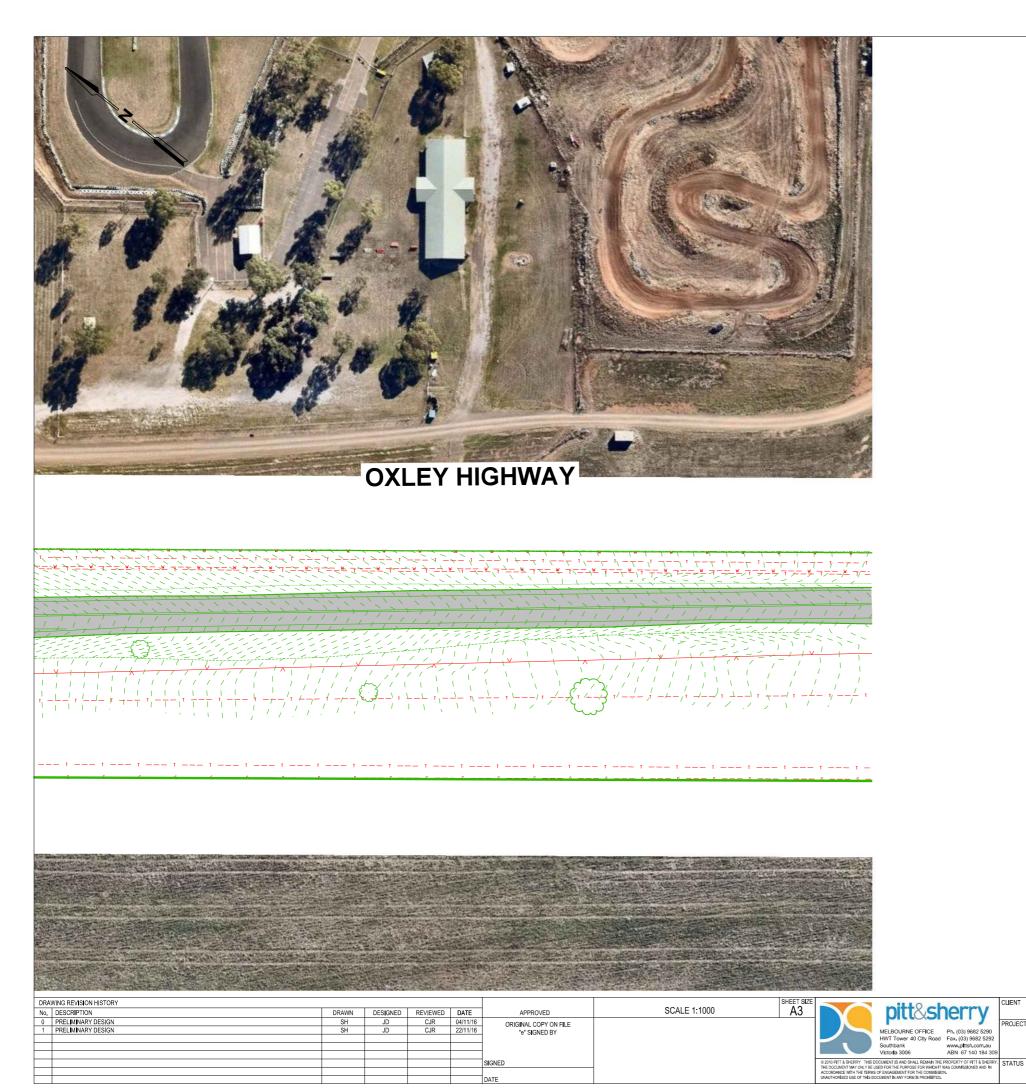

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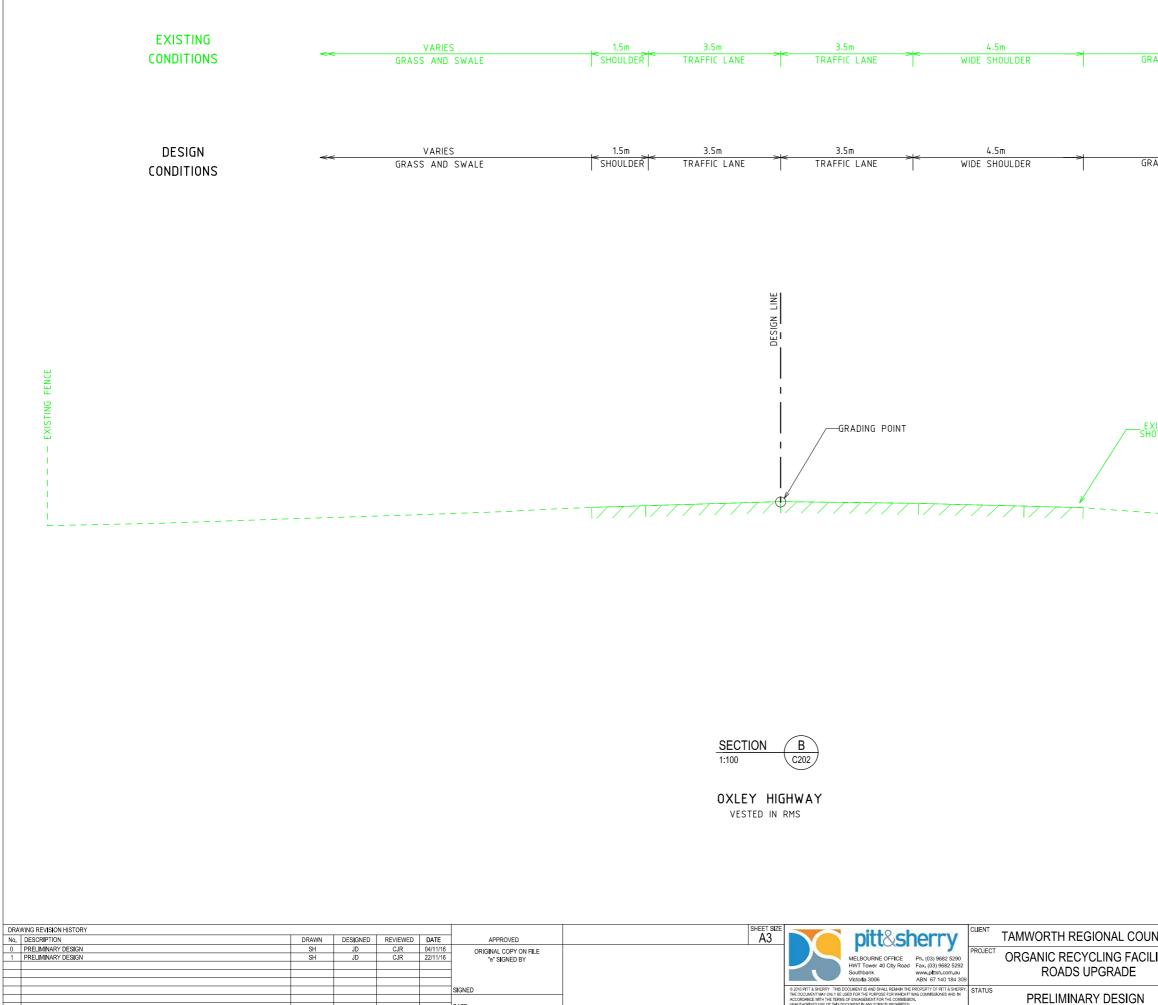
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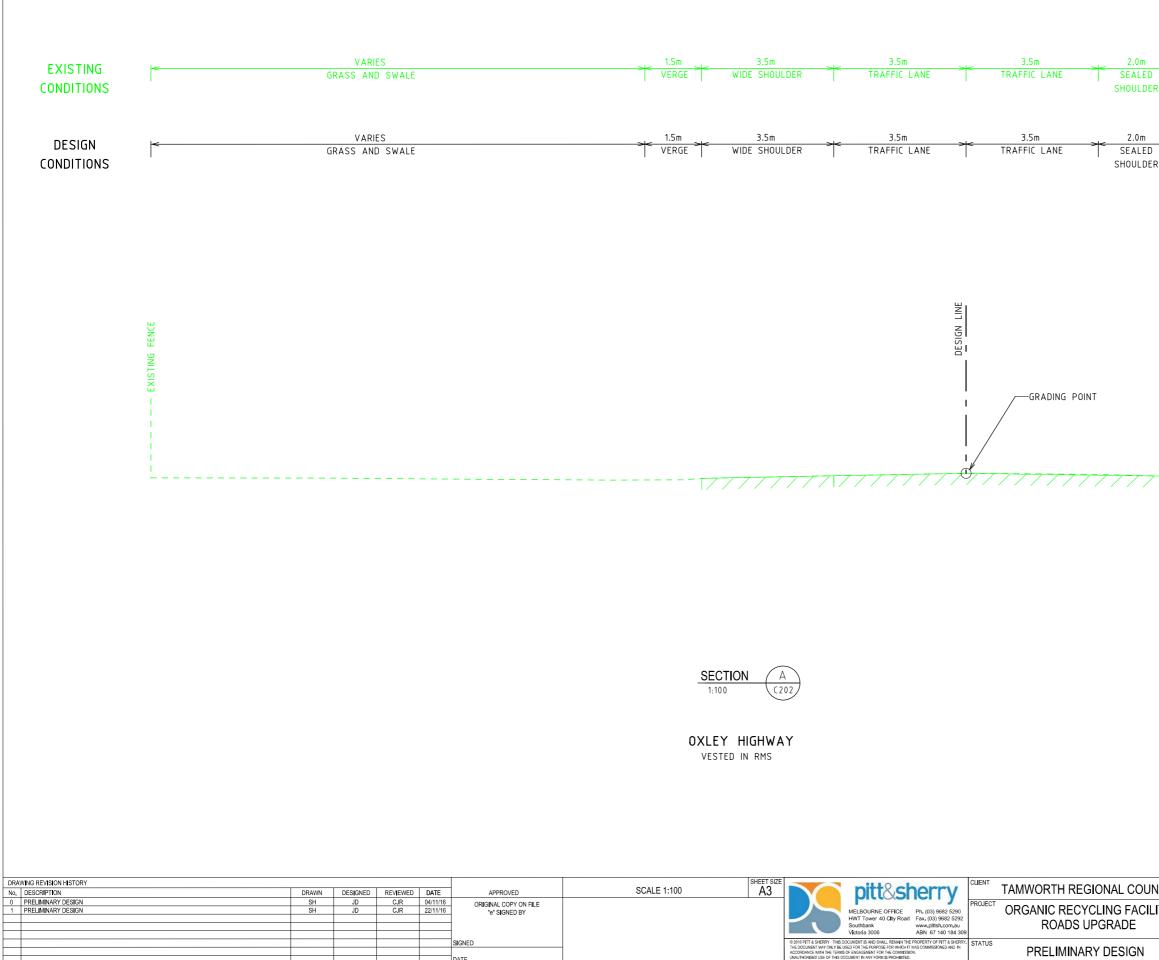
VARIES GRASS AND SWALE

VARIES GRASS AND SWALE
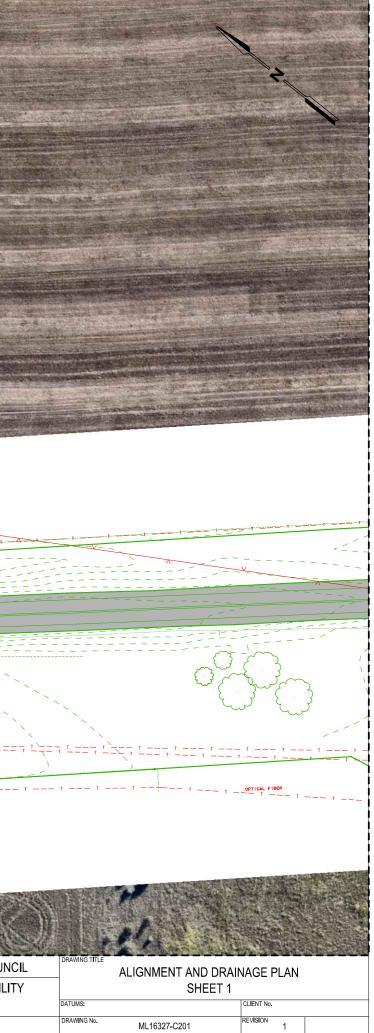
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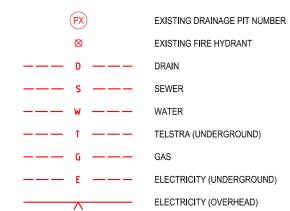


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PRELIMINARY DESIGN

EXISTING SERVICES LEGEND



GENERAL LEGEND

SM3 - SM2

BCTA

BCTB

NJB

BREAKAWAY CABLE TERMINAL (BCTA) REFER SD 3541 AND SD 3571 BREAKAWAY CABLE TERMINAL (BCTB) REFER SD 3542 CONCRETE BARRIER 700mm WIDTH REFER SD 3901D

KERB AND CHANNEL (SD 2001)

EXISTING SEALED PAVEMENT

DRAINAGE LEGEND


	DRAIN
12	DRAINAGE PIT & PIT No.
0 ⁵²	SUBSURFACE DRAINAGE PIT TYPE S2 REFER SD 1611A FOR DETAILS. FLUSHOUT RISER (REFER SD 1631)
<u> </u>	SUBSURFACE DRAIN
→ E →	CATCH DRAIN AT TOE OF BATTER (SD1531)
	GRASSED CATCH DRAIN - TYPE A (SD1521)
─► TYPE B ─►	GRASSED CATCH DRAIN - TYPE B (SD1531)

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		_			"e" SIGNED BY	MELBOURNE OFFICE Ph. (03) 9682 5290 PRUEL ORGANIC RECYCLING FACILITY
					-	HWT Tower 40 City Road Fax. (03) 9682 5292 Southbank www.ptitsh.com.au ROADS UPGRADE
					-	Victoria 3006 ABN 67140184309
		+			SIGNED	© 2010 1711 & SHERRY. THIS DOCUMENT IS AND SHALL REMAIN THE PROPERTY OF 1711 & SHERRY. STATUS
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NOTES: SETOUT

1.

UNLESS NOTED OTHERWISE, SET OUT POINTS ARE TO LIP OF KERB OR FACE OF NJB. 2.

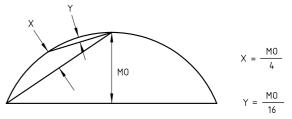

CURVE SET-OUT DETAIL

NOTES: DRAINAGE

PIPE MATERIALS UNLESS NOTED OTHERWISE:

DRAINAGE PIPES 225mm AND LARGER

DRAINAGE PIPES 150mm AND SMALLER

SUBSURFACE DRAINS (LONGITUDINAL)


SUBSURFACE DRAINS (TRANSVERSE AND UNDER

ALL COORDINATES ARE TO AMG ZONE 55 AND REDUCED LEVELS ARE TO AHD.

	- RCP 2 RRJ
	- uPVC CLASS SH RRJ
	- TYPE 3 (SD 1601C) - CATEGORY 1 PIPE WITH FILTER SOCK - CLASS A2 GRANULAR FILTER MATERIAL
R ROADS)	- TYPE 2 (SD 1601C) - CATEGORY 1 PIPE

- NO FINES CONCRETE FILTER MATERIAL

ICIL ITY	DRAWING TITLE	SYMBOLS AND GENER	AL NOTES	
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]				Southbank	www.pittsh.com.au	
		1				Victoria 3006	ABN 67 140 184 30	
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KEY CRITERIA FOR DESIGN

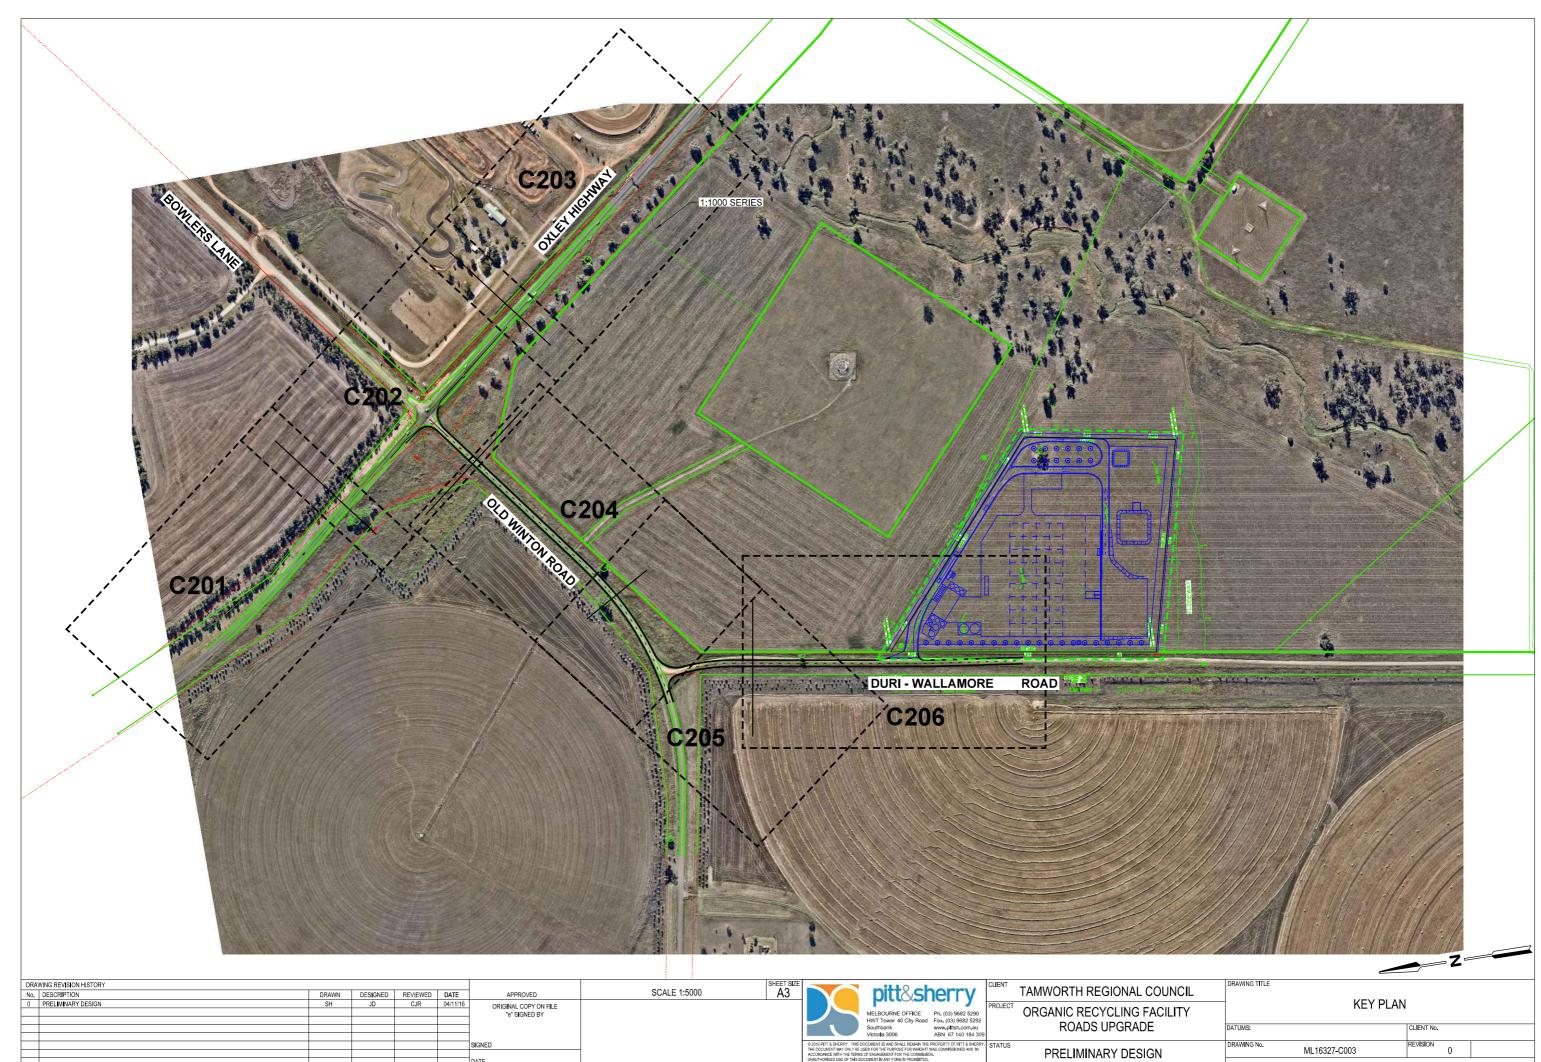KEY CRITERIA FOR REFERENCE: AUSTROADS GUIDE TO ROAD DESIG		DESIGN NOTES	
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1. DESIGN SPEED		APPROACH).	
DESIGN SPEED	= V100		
2. TYPICAL CROSS SECTION (ASSUME AADT= 1			
LANE WIDTHS SHOULDER WIDTHS	= 3.5m (TABLE 4.5) = 2.0m (TABLE 4.5)		
	= 1.0m (TABLE 4.5)		
VERGE SUPPORT WITH GUIDE POST VERGE WITH SAFETY BARRIERS	= 1.5m (TABLE 4.9) = 1.5m (TABLE 4.9)		
BATTER SLOPES (DESIRABLE) - 4-6H :1V CUT - 4-6H :1V FILL			
3. SIGHT DISTANCE			
CAR SSD = CAR ASD (FWY/HWY)			
CAR SSD = CAR ASD (RURAL ROADS) CAR SISD	= 165m (TABLE 5.4, RT= 2.0 SEC) = 248m (AGRD PART 4A, TABLE 3.2)		
4. HORIZONTAL ALIGNMENT			
CURVES IN ACCORDANCE WITH FIGURE-7 SUPERELEVATION IN ACCORDANCE WITH			
	R Φ 500m (TABLE 7.2)		
MINIMUM SPIRAL LENGTH	= 55m (TABLE 7.3)		
5. VERTICAL ALIGNMENT			
MAXIMUM GRADE MINIMUM VERTICAL CURVE LENGTH	= 3-5% (TABLE 8.3, FLAT)		
MINIMUM SAG CURVATURE, K			
MINIMUM CREST CURVATURE, K	= 95.7 (TABLE 8.7) - CAR STOPPING SIGHT	DISTANCE (AGRD PART 4A; TABLE 3.1 K =124)	
	= 124.0 – APPROACH SIGHT DISTANCE (AGR = 66.0 – INTERSECTION SIGHT DISTANCE (AG		
REFERENCE FILES: survey			
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PROJECT ML16180 (SITEWORKS DESIGN)			
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ML16327-X-CHAINAGE.dgn	CHAINAGE STATION		
ML16327-X-PAVEMENT.dgn	PAVEMENT AREAS		
ML16327-X-DRAINAGE LAYOUT.dgn ML16327-X-SITE BDY	DRAINAGE LAYOUT SITE BOUNDARY		
ML16327-X-TRUCK PATHS	TRUCK TURNING PATHS		
ML16327-X-SETOUT POINTS.dgn DESIGN MODEL	SETOUT POINTS		
EXISTING SURFACE.DTM	DIGITAL TERRAIN MODEL		
DESIGN SURFACE.DTM	DESIGN SURFACE		
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REFERENCE: TAMWORTH 34619-2016 SUBDIVISION GUIDELINES VERSION - DECEMBER 2014

GEOMETRY 1. DESIGN SPEED DESIGN SPEED	=	V100	
	= =	3.5m 1.0m 1.5m 1.5m	(TA (TA
BATTER SLOPES MAXIMUM CUT FILL 2H: 1V			
3. SIGHT DISTANCE IN ACCORDANCE WITH AGRD PART 3			
4. HORIZONTAL ALIGNMENT MINIMUM RADIUS OF HORIZONTAL CURVES	5	N ACI	CORD
MAXIMUM GRADE ON OTHER ROADS MAXIMUM DISTANCE MAXIMUM GRADE	= =	1% 16%	(PAR (PA (PA
6. SUPER ELEVATION SUPERELEVATION IN ACCORDANCE WITH A MAXIMUM SUPER ELEVATION OF CURVE II MAXIMUM SUPER ELEVATION OF CURVE II	Ν	BUILT	UP
7. TABLE DRAIN GUTTERS OR TABLE DRAINS ARE TO HA'	VE	A M	INIMU

GUTTERS OR TABLE DRAINS ARE TO HAVE A MINIMUM GRADE =1% $\ensuremath{\mathsf{C}}$ WHERE TABLE DRAINS EXCEEDS 6% A CONCRETE LINED DRAIN SHALL BE REQUIRED IN ACCORDANCE WITH SD 6475

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PART 2-TABLE B ROAD CLASSIFICATIONS AND FORMATION WIDTH, LOCAL, RU4) ABLE 4.5) ABLE 4.9) ABLE 4.9)

RDANCE TABLE D

ART 2-TABLE E) ART 2-TABLE E) PART 2-TABLE E) PART 2-TABLE E) ART 2-TABLE E)


ART 2-TABLE E)

3 SECTION 7.7-SUPER P AREA =4.0% AREA =7.0%

FOR INFORMATION ONLY

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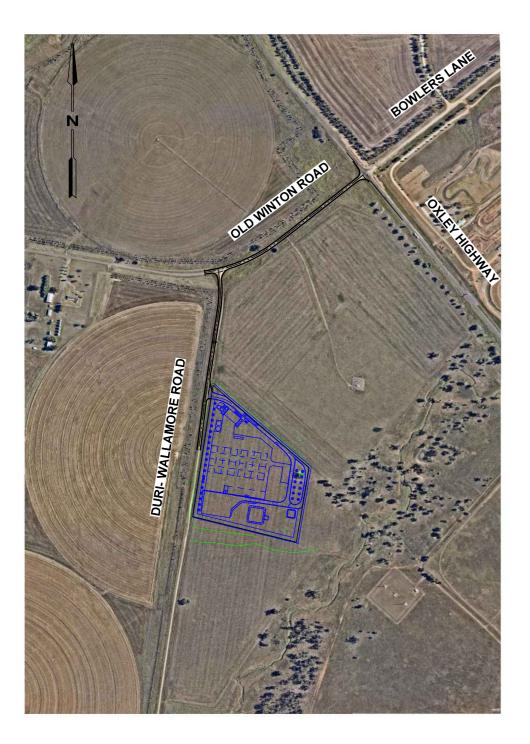


TRAFFIC REPORT

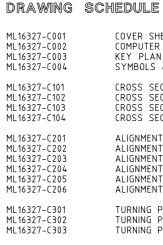ML16180H001

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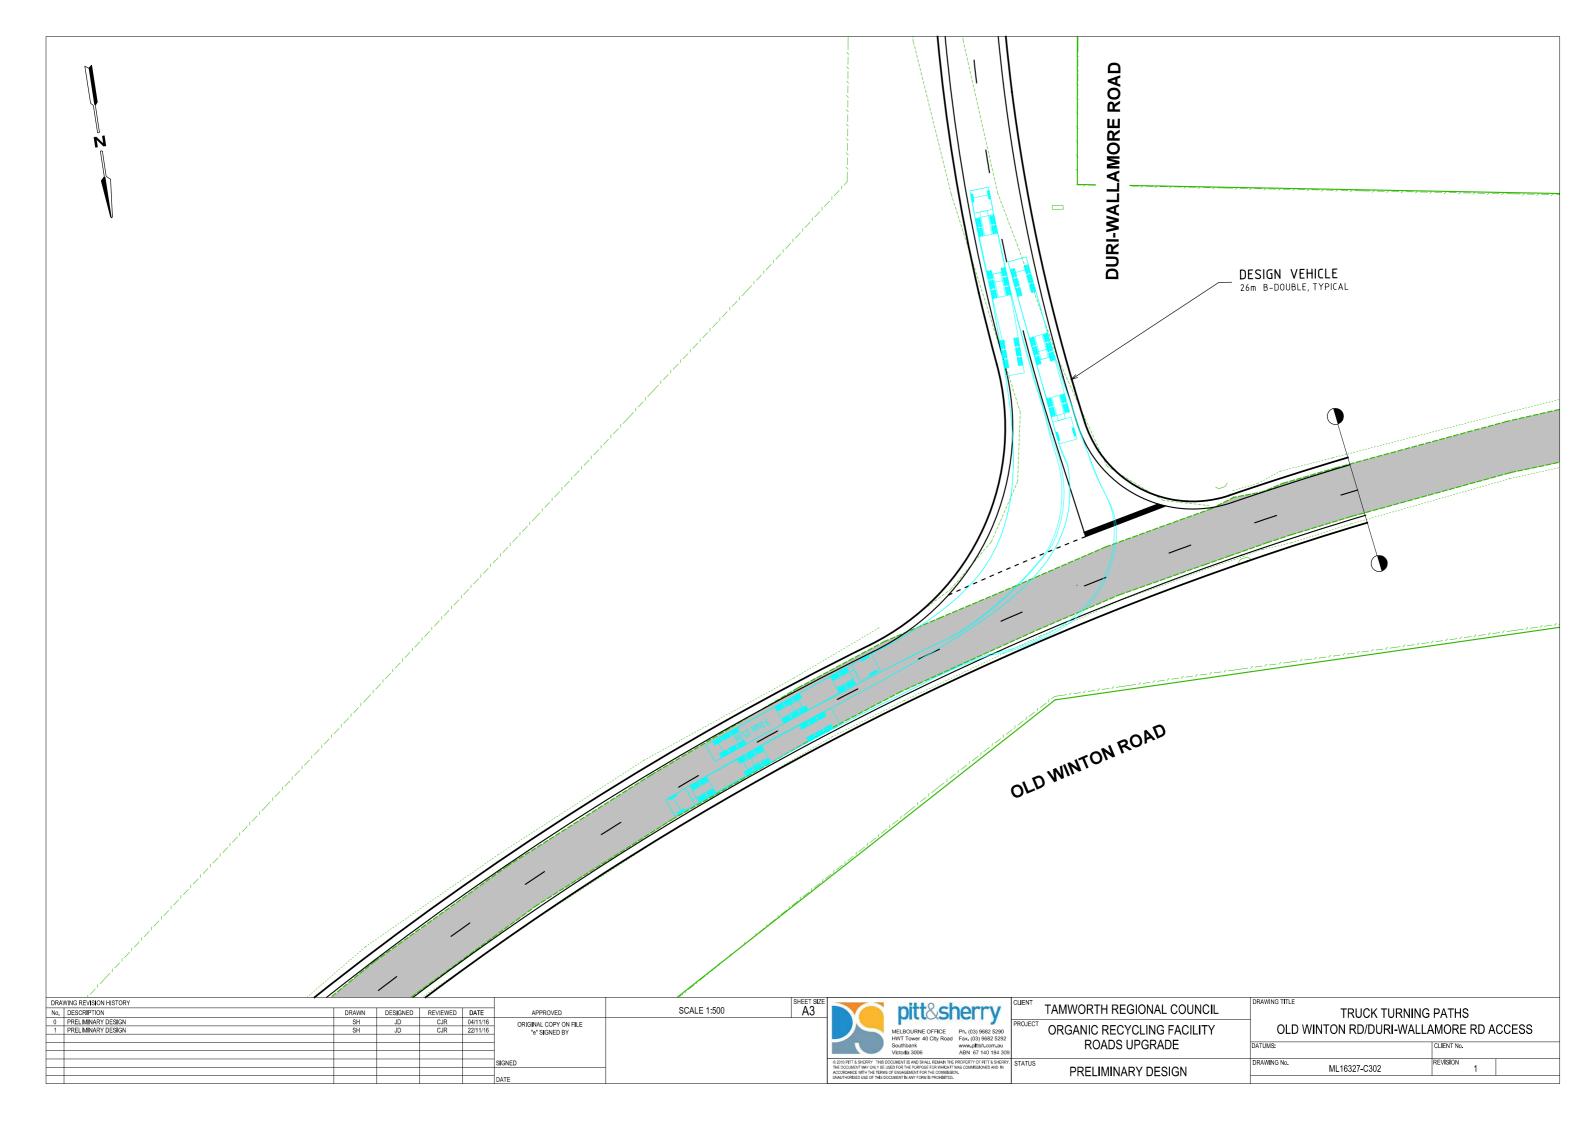
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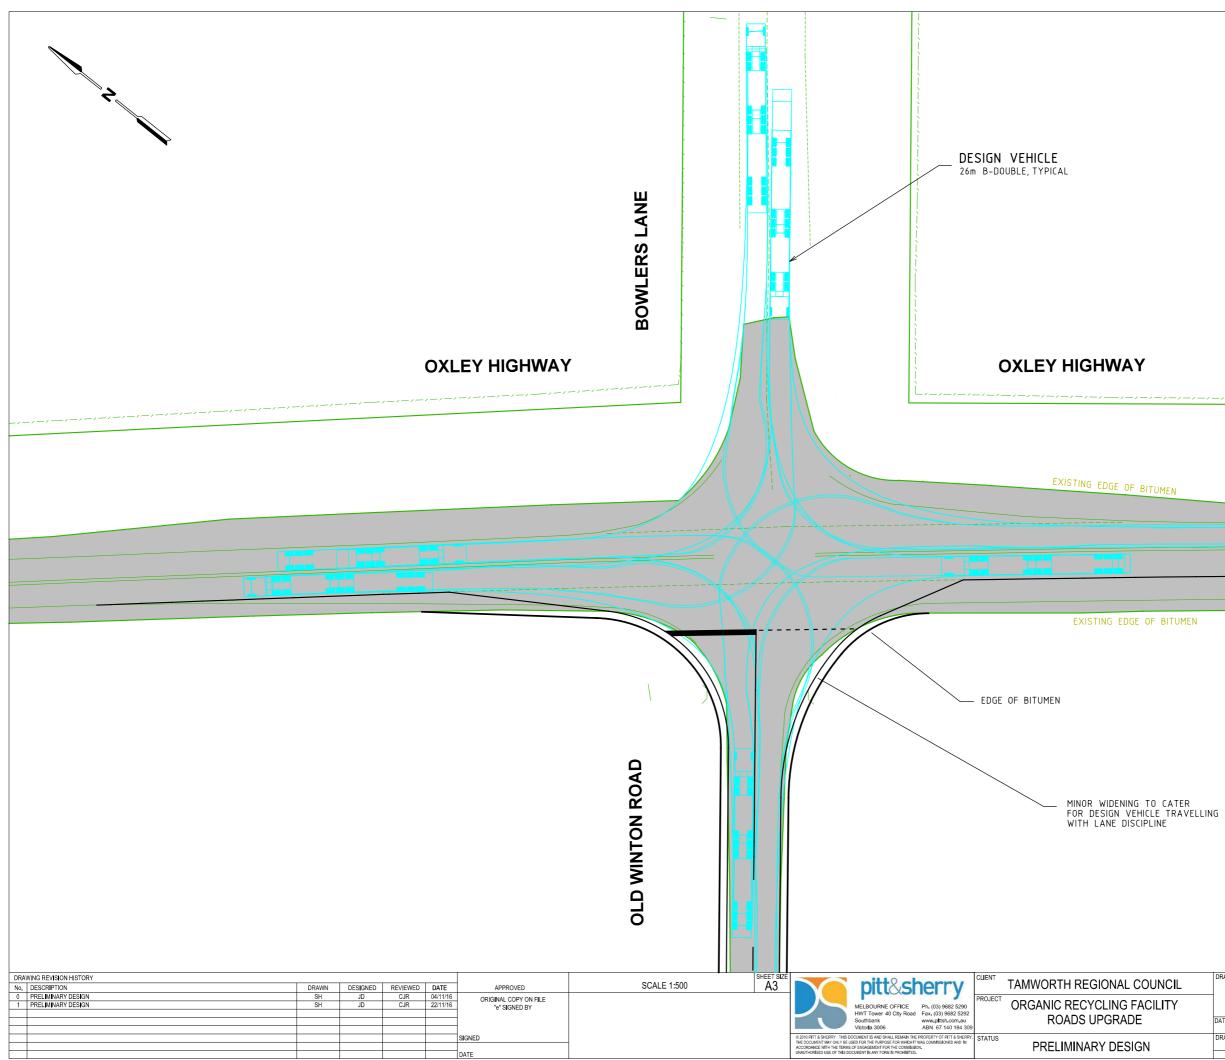


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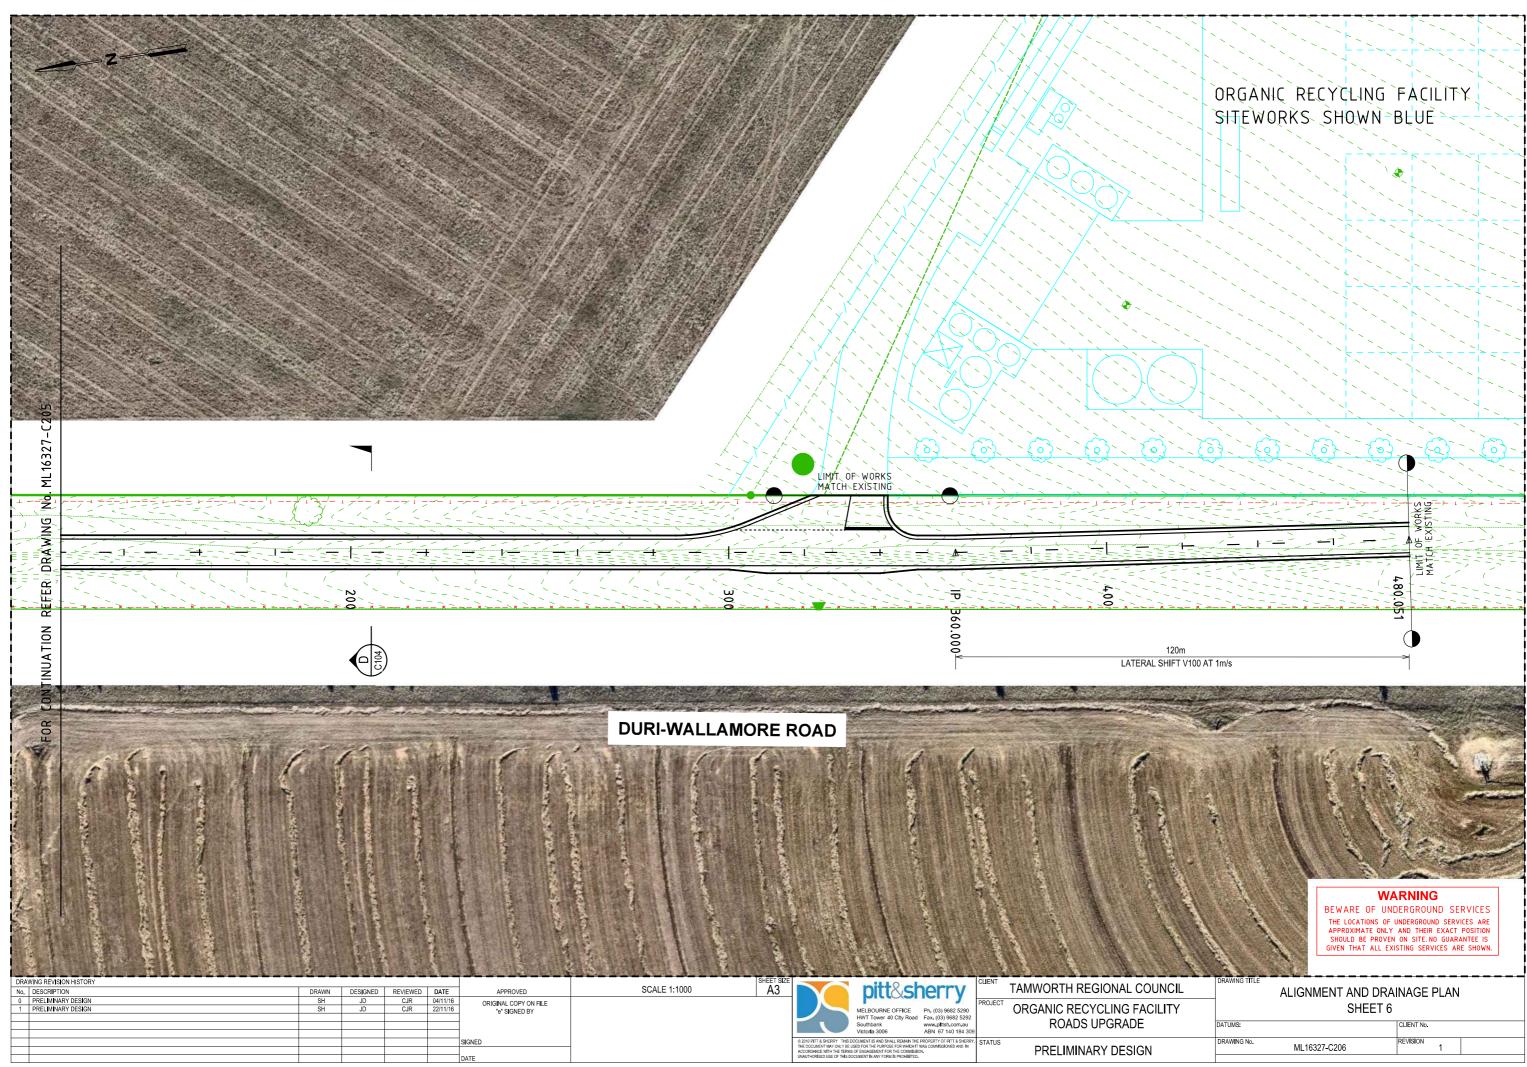
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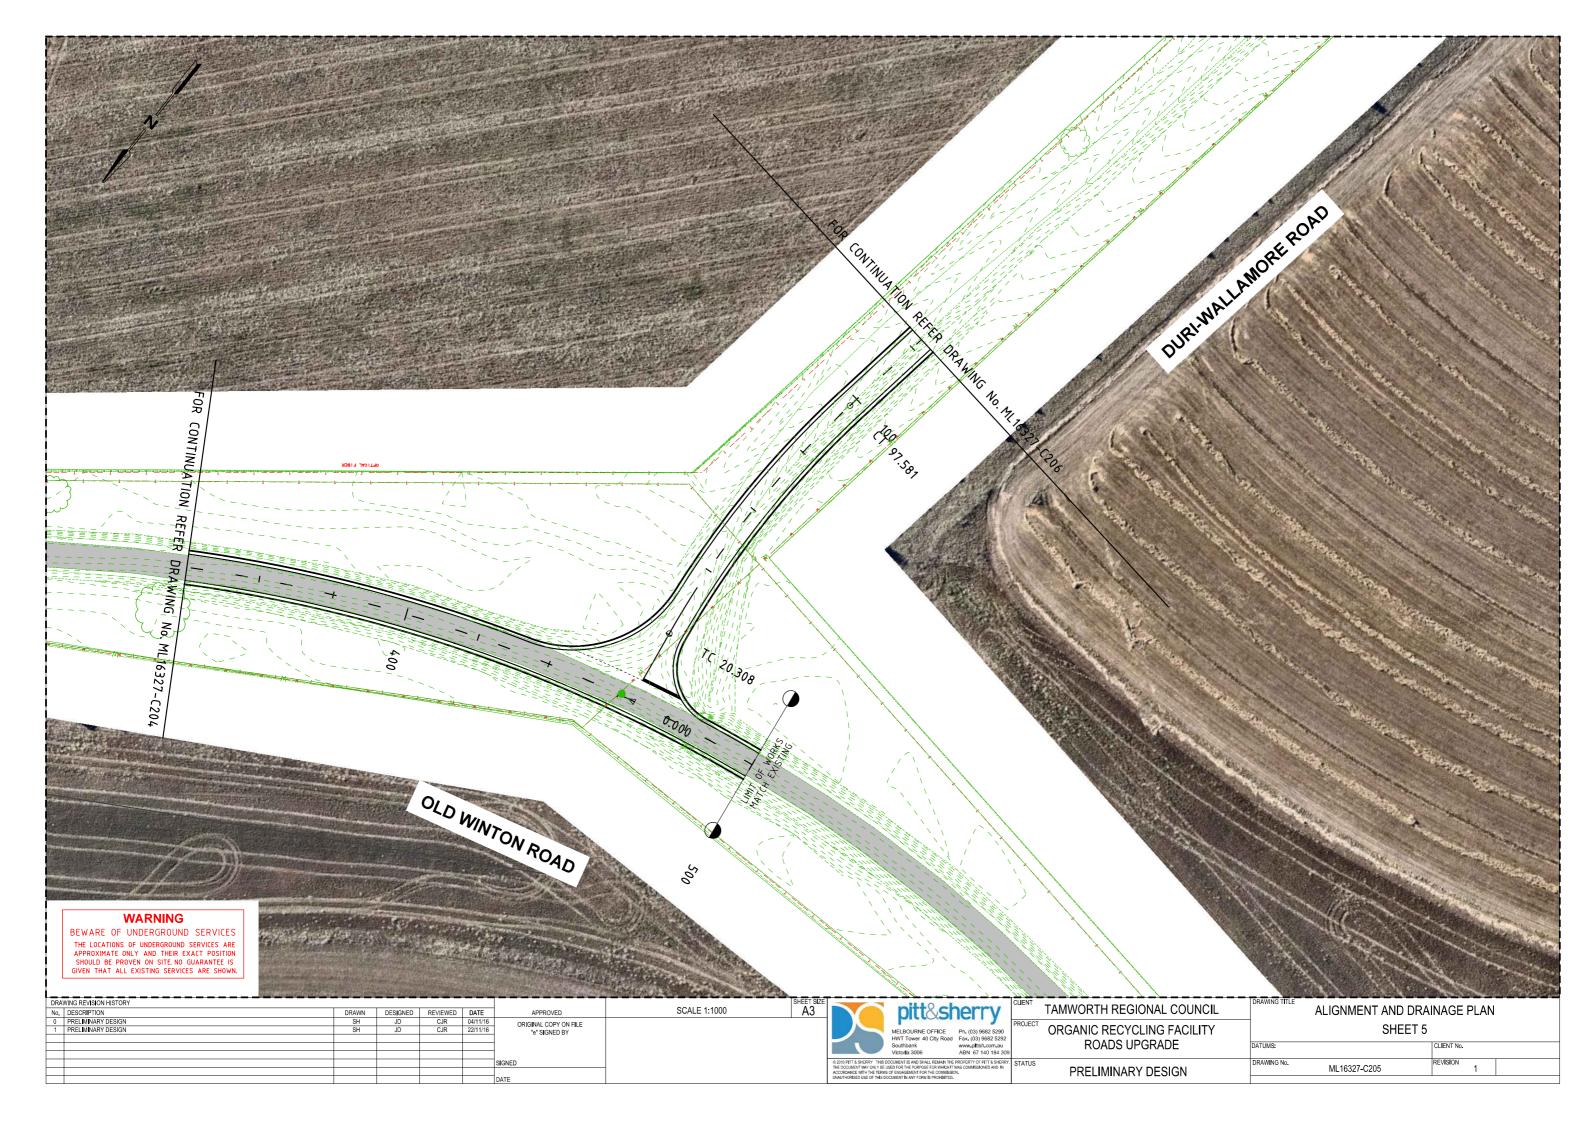
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SCOPE OF WORK:

SUPPLY, INSTALLATION AND TESTING OF RECLAIM WATER SYSTEM SERVICES AS DETAILED IN THIS DOCUMENT AND IN ACCORDANCE WITH CONDITIONS OF CONTRACT.

THE CONTRACTOR SHALL:

- PROVIDE FOR ALL NEW MATERIALS.
- PROVIDE ALL LABOUR, POWER, CARTAGE, TOOLS, PLANT ETC REQUIRED TO COMPLETE THE INSTALLATION. • INCLUDE ALL MINOR AND INCIDENTAL WORK NECESSARY THOUGH NOT SPECIFICALLY MENTIONED HEREIN TO COMPLETE THE SERVICES TO THE TRUE INTENT AND MEANING OF THIS DRAWING.
- THE WORK WILL BE COMPLETED TO THE ENTIRE SATISFACTION OF THE SUPERINTENDENT.

THE WORK COMPRISES:

- 1. INSTALL 150mm BRANCH CONNECTION WITH ISOLATION VALVE INTO THE 450mm. RECLAIM WATER RISING MAIN AFTER DIVERTING THE 450mm PIPE ABOVE GROUND.
- PROVIDE A 2m CYCLONE FENCE AROUND ABOVE GROUND RECLAIM WATER MAIN.
- ENSURE THERE IS SUFFICIENT ROOM WITHIN THE ENCLOSE FOR MAINTENANCE AND INCLUDE A LOCKABLE PEDESTRIAN DOOR.
- SUPPLY AND INSTALL FLOW TRANSMITTER IN THE RECLAIM WATER RISING MAIN.
 SUPPLY AND INSTALL "PUMP SHED" WITH A LOCKABLE DOOR WITH SUFFICIENT SIZE TO ALLOW THE EQUIPMENT TO BE REMOVED FOR MAINTENANCE. THE SHED WILL HAVE A CONCRETE FLOOR AND WILL HOUSE THE PUMP P1 AND ASSOCIATED VALVES AND CONTROLS. 4
- SUPPLY AND INSTALL LOCAL ELECTRICAL CABINET IN PUMP SHED. 5.
- SUPPLY AND INSTALL CONCRETE PIT IN LEACHATE DAM.
- 6. SUPPLY AND INSTALL TWO OFF RECLAIM WATER TANKS EACH WITH AN EFFECTIVE WATER CAPACITY OF 165,000 LITRES EACH.
- 7. SUPPLY AND INSTALL INTERCONNECTING PIPEWORK AND VALVES BETWEEN THE RECLAIM WATER TANKS.
- 8. SUPPLY AND INSTALL ALL RETICULATION PIPEWORK, VALVES AND PUMPS AS INDICATED ON RECLAIM WATER SCHEMATIC DRAWING ML16327-SKH500.
- 9. SUPPLY AND INSTALL FLOAT ISOLATION VALVES IN EACH OF THE RECLAIM WATER TANKS.
- 10. SUPPLY AND INSTALL LEVEL TRANSMITTERS IN LEACHATE DAM PIT AND EACH OF THE RECLAIM WATER TANKS.
- 11. SUPPLY AND INSTALL DISCHARGE PIPE WORK, PUMP AND VALVES TO RECLAIM WATER TANKS.
- 12. SUPPLY AND INSTALL UV WATER FILTRATION EQUIPMENT, BYPASS PIPEWORK AND VALVES.
- 13. CONNECT RECLAIM WATER LINE FROM UV FILTER TO TRUCK WHEEL WASH (SUPPLIED BY OTHERS)
- 14. SUPPLY ALL ELECTRICAL WIRING, ELECTRICAL PANELS, AND CONTROLS TO OPERATE THE RECLAIM WATER SYSTEM.
- 15. CO-ORDINATION WITH ALL OTHERS DURING INSTALLATION.
- 16. SHOP DRAWINGS, AS 'INSTALLED' AND OPERATING AND MAINTENANCE MANUALS.

INSTALLATION:

PIPE WORK:	TO MANUFACTURES RECOMMENDATIONS AND AS3500.
ELECTRICAL:	TO AS3000.
CONTROLS	INDICATED ON THE DRAWING AND IN ACCORDANCE WITH THE MANUFACTURES INSTRUCTIONS.

REF	ERENCE FILES ATTACHED:													
DR	AWING REVISION HISTORY						SCALE	AS SHOWN (A3)	SHEET SIZE				CLIENT	
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												wer 40 City Road Fax. (03) 9682 5292		
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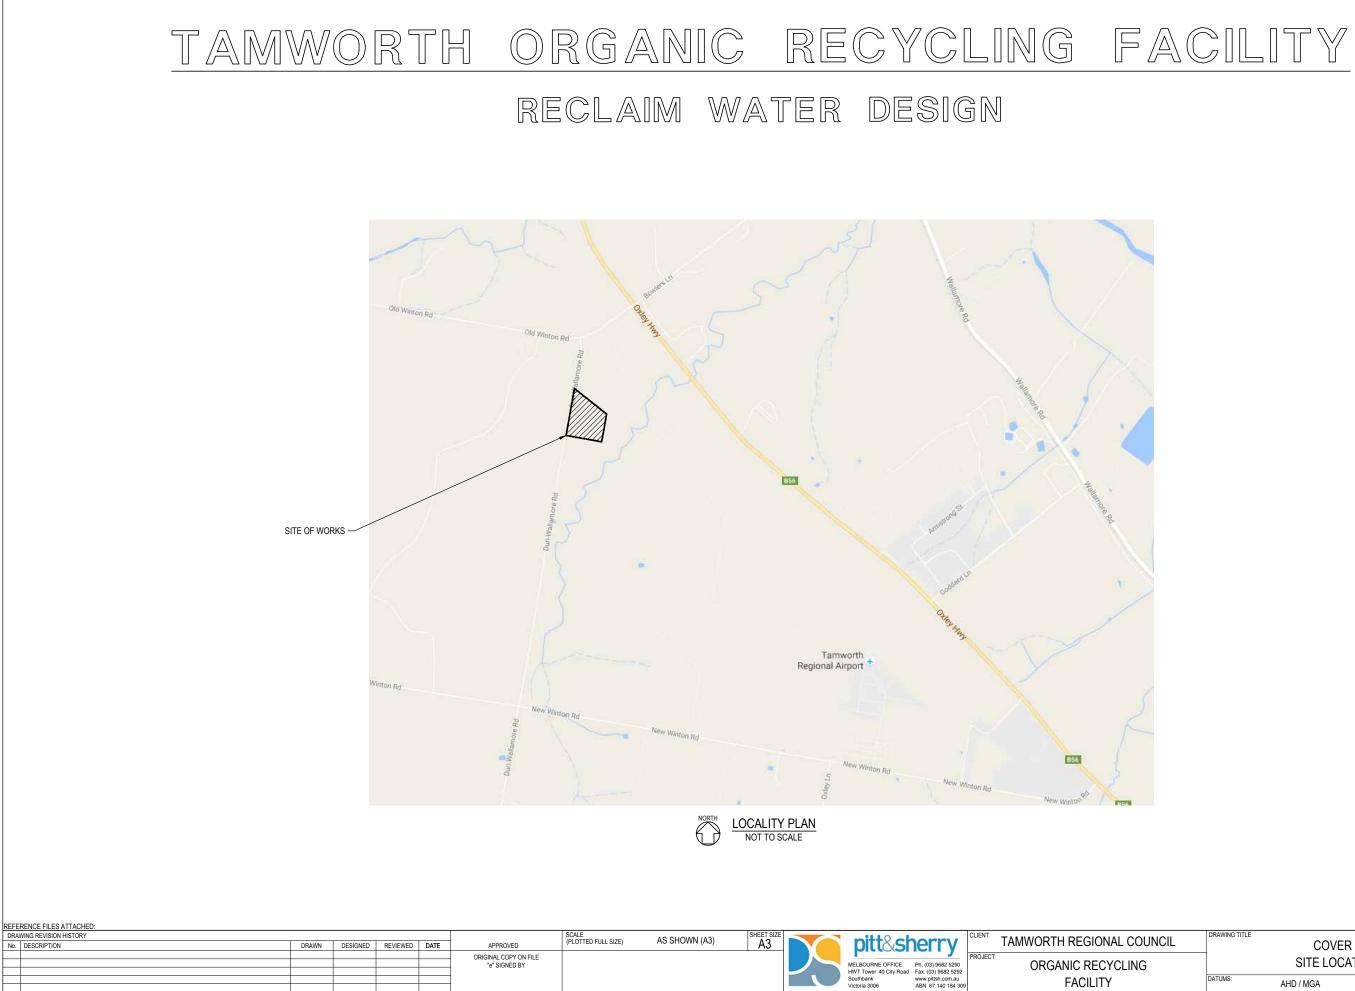
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TABLE OF CONTENTS										
DRAWING NUMBER	REV	DESCRIPTION								
ML16327-H001	A	COVER SHEET - SITE LOCATION PLAN								
ML16327-H002	В	SHEET INDEX								
ML16327-H003	A	GENERAL NOTES								
ML16327-H004	A	EQUIPMENT SCHEDULE								
ML16327-H010	В	RECLAIM WATER SITE LAYOUT								
ML16327-H500	A	RECLAIM WATER SCHEMATIC								

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CIL	COVER SHEET	T T
	SITE LOCATION P	LAN
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PRELIMINARY

CONTROLS OPERATIONS:

MAIN

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WATER

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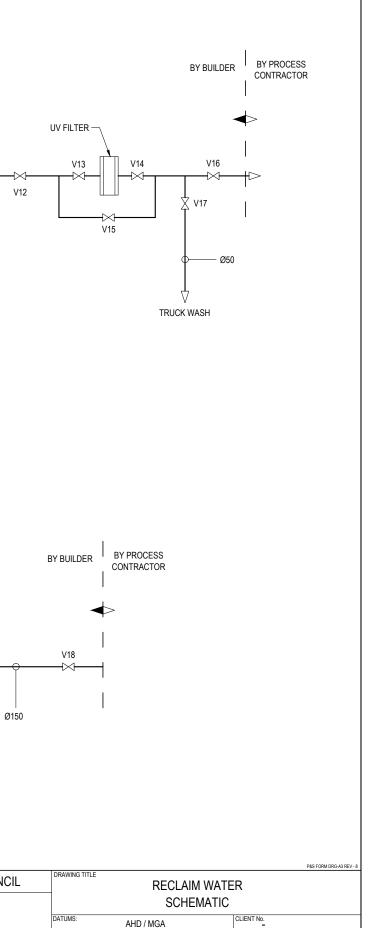
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P1 IS A PRESSURE CONTROLLED PUMP. V1 IS A MOTORISED VALVE THAT IS NORMALLY CLOSED. P2 IS A PRESSURE CONTROLLED PUMP. M1 IS A WATER METER. IF NO FLOW DETECTED IN RISING MAIN Ø100 1. P1 IS OFF 2. V1 IS CLOSED LT LT PUMP P1 <u>CAN ONLY OPERATE</u> IF 1. FLOW IN RISING MAIN CONFIRMED 2. V1 CONFIRMED OPEN V8 V10 FV1 FV2 🖂 FOR NORMAL OPERATION THE PUMP P1 WILL MAINTAIN CONSTANT PRESSURE IN THE PIPE SYSTEM, UTILIZING THE V9 CONTROL SYSTEM PROVIDED BY THE PUMP MANUFACTURE. PUMP STATUS IS RELAYED TO THE CONTROL SYSTEM. **RECLAIM TANK 1** \bowtie RECLAIM TANK 2 Ø150 IF HIGH LEVEL DETECTED IN BOTH RECLAIM WATER TANKS AND LEACHATE DAM PIT Ø100 ABOVE GROUND 1. P1 IS TURNED OFF 2. V1 IS CLOSED V11 P2 3. NOTE P1 MUST BE OFF BEFORE V1 IS CLOSED PUMP P2 CAN ONLY OPERATE IF: 1. THE WATER LEVEL IN THE RECLAIM WATER TANK IS 500MM (ADJUSTABLE) ABOVE VORTEX LEVEL OF THE TANK OUTLET. 2. THE PRESSURE IN THE PIPE LINE DROPS BELOW THE PRE-SET VALUE OF THE PUMP PACKAGE. FOR NORMAL OPERATION THE PUMP P2 WILL MAINTAIN CONSTANT PRESSURE IN THE PIPE SYSTEM, UTILIZING THE CONTROL SYSTEM PROVIDED BY THE PUMP MANUFACTURE WATER METER: THE RECLAIM WATER USAGE IS TO BE RELAYED TO THE CONTROL SYSTEM FOR THE CONTROL SYSTEM MONITOR AND REPORT ON RECLAIM WATER USAGE UV FILTER: THE UV FILTER WILL OPERATE USING THE CONTROLS PROVIDED WITH THE UNIT. Ø100 U/G Ø150 U/G Ø150 U/G LT FS V2 7 V7 V19 V3 1// V6 P1 V5 Ø100 2ML CAPACITY LINE 1.5ML CAPACITY LINE PIT INSERT 6ML LEACHATE DAM

> SCHEMATIC N.T.S.


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				<u> </u>	-					Victoria 3006	ABN 67 140 184 30	19	FACILITY
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DRAWING No. ML16327-H500

Nov. 16, 16 - 12:37:04 Name: ML16327-H500.dwg Updated By: Nishal Wir

REVISION



MATERIALS:

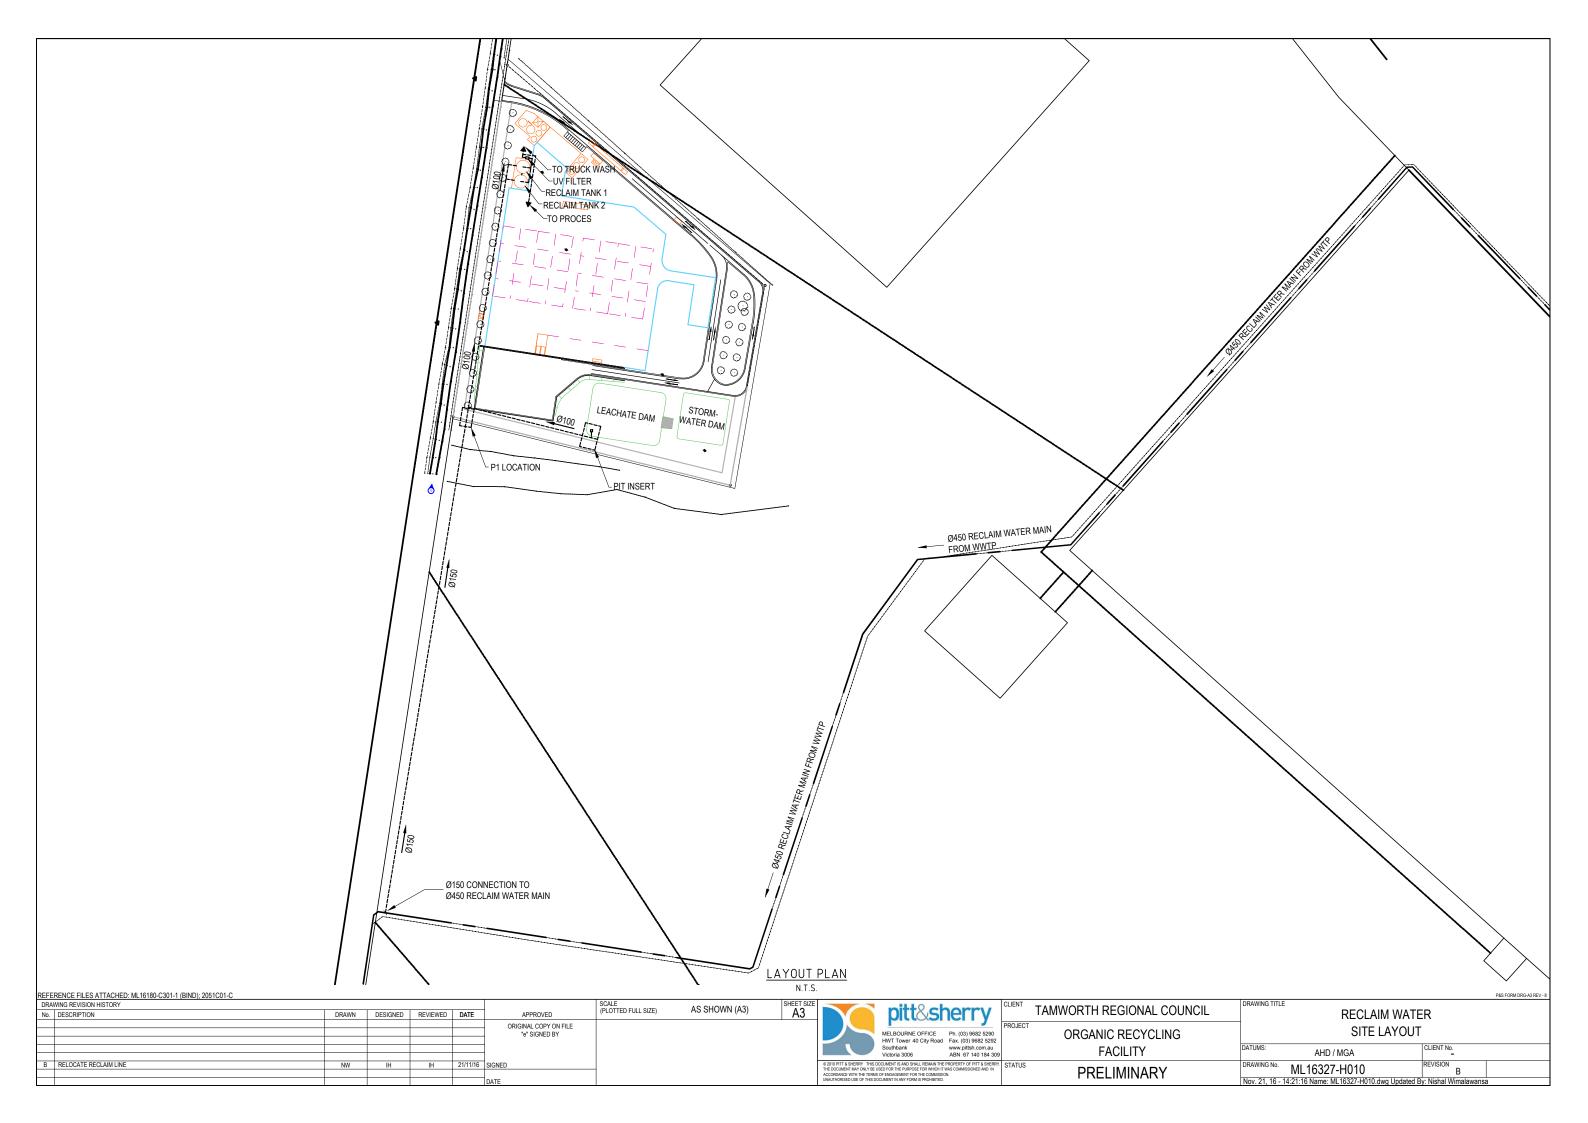PIPE WORK BELOW GROUND:PE 100 ALL IN ACCORDANCE WITH AS/NZ 4130.PIPEWORK ABOVE GROUND:PE 100 ALL IN ACCORDANCE WITH AS/NZ 4130.

CONTROLS:

SCADA CONTROL SYSTEM USING DANFOSS, OR SIEMENS, OR ALLEN BRADLEY. ALL EXTERNAL SENSORS TO BE IP65 RATED.

MISCELLANIOUS ITEMS										
Description	M a n u facture	ModelNo	Flemarks.							
UV WaterFilter	Southland or equal	U V - H E - 12	70 watttube							
Water Meter	Krohne orequal	Optiflex 1000	cłw signal converter to be compatable to site control system. Formore information refer to drawing notes							
Reclaim Water Tanks	Tasman	165 k Litre	7,5m dia,4,13m high,Colourbondsteel construction.							
Level Transmitter	Allen Bradley or similar		Compatiable with site control systems							


PUMPS - WATER		
EQUIPMENTNo	P - 0 1	P - 0 2
MAKE	GRUNDFOSS	GRUNDFOSS
TYPE (LONG COUPLED, END SUCTION, IN-LINE)	IN - LINE	IN - LINE
MODEL No.	Hydro MPC-E2 CRE	Hydro MPC-E2CRE
DUTY (Lis @ kPa)	14 / 4 5 0	1.3 / 2 6 0
WATER TEMP FLOW "C / RETURN "C	35 ºC	35 ºC
MOTOR (KW)	2 @ 7.5kW 3ø	2 @ 0.75kW 3ø
ELECTRICAL DISTRIBUTION BOARD		
COMMENTS	Reclaim Water	Reclaim Water
contractors are to verify the pump heads against the pr	oposed pipe work layout.	
All pump motors are to be IP65 rated		
Allseals to be BUNA - Norequal		

			VALVE SCHEDULE					
ID	Description	Location	Туре	Seals	Manufacture	Size mm	Actuator	Remarks
° 1	Organic Recycling Facility Isolation Valve	At Reclaim Water Rising Main	Resilien t Butterfly valve series 30/31	BUNAN seal	Bray or Similar	150	Manual	Nylon coated ductile iron blade
2	Control Valve	Next to Leachate Dam	Resilien t Butterfly valve series 30/31	BUNAN seal	Bray	150	Electric motor	Nylon coated ductile iron blade
' 3	Isolation Valve for Pump P1	Nextto Leachate Dam	Resilien tButterfly valve series 30∤31	BUNAN seal	Bray	150	Manual	Nylon coated ductile iron blade
/ 4	Isolation Valve for Pump P1	Next to Leachate Dam	Resilient Butterfly valve series 30/31	BUNAN seal	Bray	150	Manual	Nylon coated ductile iron blade
/ 5	Check valve for pump P1	Nextto Leachate Dam	Ritepro Check Rite valve model 210	Viton seal	Bray	100	Manual	316 L stain less steel flap
/ 6	Isolation valve forbranch to reclaim tanks	Next to Leachate Dam	Resilien tButterfly valve series 30∤31	BUNAN seal	Bray	10.0	Manual	Nylon coated ductile iron blade
/ 7	Isolation valve forbranch to leachate Dam	Next to Leachate Dam	Resilien t Butterfly valve series 30/31	BUNAN seal	Bray	100	Manual	Nylon coated ductile iron blade
/ 8	Isolation Valve to Reclaim Tank 1	Rieclaim tan ks	Resilien tButterfly valve series 30∤31	BUNAN seal	Bray	10 0	Manual	Nylon coated ductile iron blade
/ 9	Isolation Valve between reclaim tanks	Reclaim tanks	Resilien tButterfly valve series 30∤31	BUNAN seal	Bray	150	Manual	Nylon coated ductile iron blade
10	Isolation Valve to Reclaim Tank 2	Reclaim tan ks	Resilien t Butterfly valve series 30∤31	BUNAN seal	Bray	10.0	Manual	Nylon coated ductile iron blade
11	lsolation valve to pump P 2	Reclaim tan ks	Resilien tButterfly valve series 30∤31	BUNA N seal	Bray	10.0	Manual	Nylon coated ductile iron blade
12	Isolation valve to pump P 2	Reclaim tanks	Resilient Butterfly valve series 30/31	BUNAN seal	Bray	5 0	Manual	Nylon coated ductile iron blade
13	lsolation valve to UV filter	Reclaim tan ks	Resilien tButterfly valve series 30∤31	BUNAN seal	Вгау	5.0	Manual	Nylon coated ductile iron blade
14	Isolation valve to UV filter	Fleclaim tan ks	Resilient Butterfly valve series 30/31	BUNAN seal	Bray	5 0	Manual	Nylon coated ductile iron blade
/ 15	Bypass valve to UV filter	Reclaimitan ks	Resilien t Butterfly valve series 30/31	BUNAN seal	Bray	50	Manual	Nylon coated ductile iron blade
16	Isolation valve to process sprays	Riecila imitan ks	Resilient Butterfly valve series 30/31	BUNAN seal	Bray	5 0	Manual	Nylon coated ductile iron blade
17	Isolation valve to truck wash	Reclaim tan ks	Resilient Butterfly valve series 30/31	BUNAN seal	BRAY	5.0	Manual	Nylon coated ductile iron blade
18	Isolation valve from Leachate Dam	Leachate dam	Resilient Butterfly valve series 30/31	BUNAN seal	Bray	150	Manual	Nylon coated ductile iron blade
19	Control Valve	Leachate dam	Resilien t Butterfly valve series 30/31	BUNAN seal	Bray	100	electric motor	Nylon coated ductile iron blade

REFERENCE FILES ATTACHED:														P&S FORM DRG-A3 REV - 8
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										Southbank www.pittsh.com.a Victoria 3006 ABN 67 140 184		DATU	MS: AHD / MGA	CLIENT No.
					SIGNED DATE	_			© 2010 PITT & SHERRY THIS I THE DOCUMENT MAY ONLY BE ACCORDANCE WITH THE TERM UNAUTHORISED USE OF THIS D	NOCUMENT IS AND SHALL REMAIN THE PROPERTY OF PITT & SHE SED FOR THE PURPOSE FOR WHICH IT WAS COMMISSIONED AND I SO FENAGEMENT FOR THE COMMISSION CUMENT IN ANY FORM IS PROHIBITED.			VING No. ML16327-H004 16, 16 - 12:34:16 Name: ML16327-H004.dwg	REVISION A Updated By: Nishal Wimalawansa

Appendix B

Site Survey

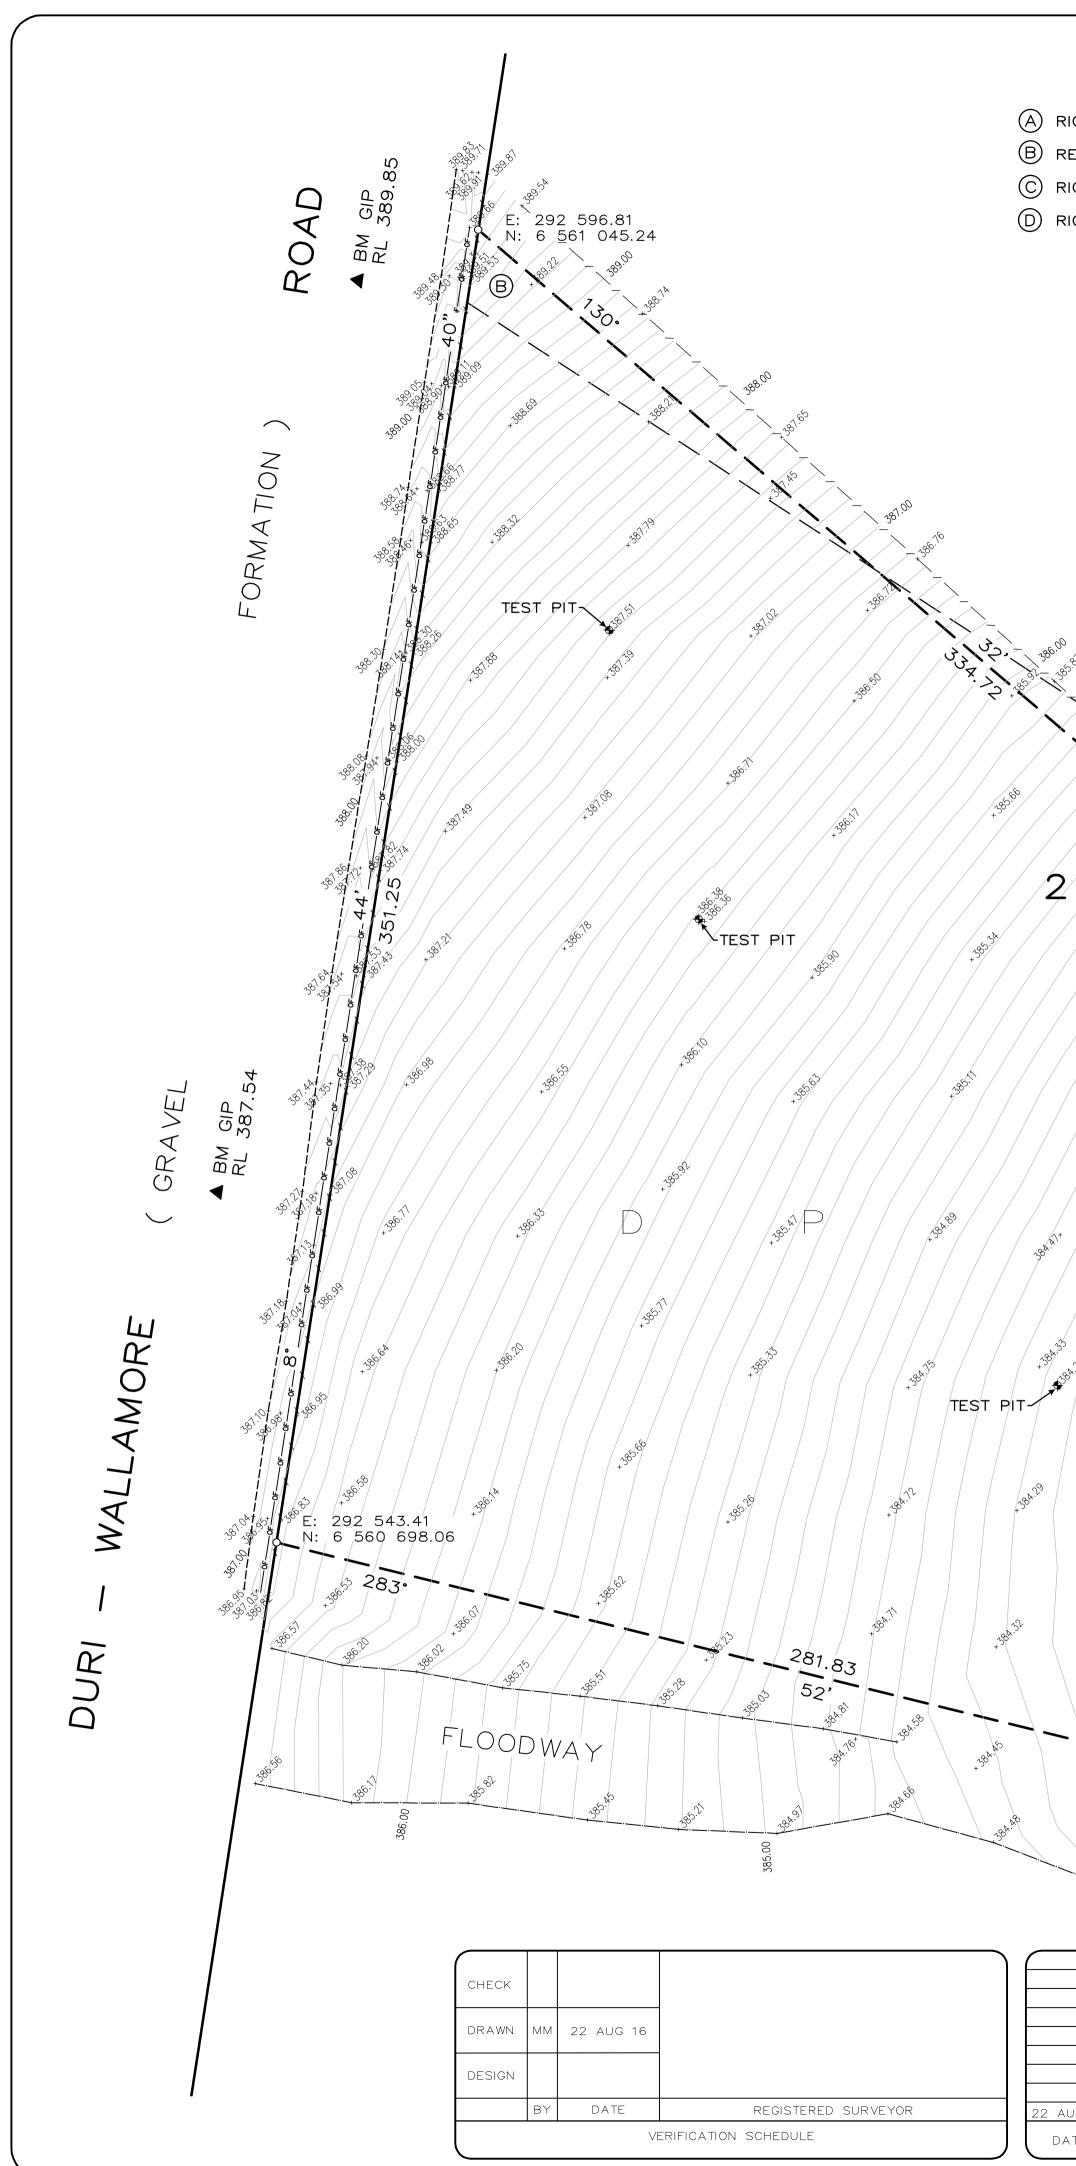

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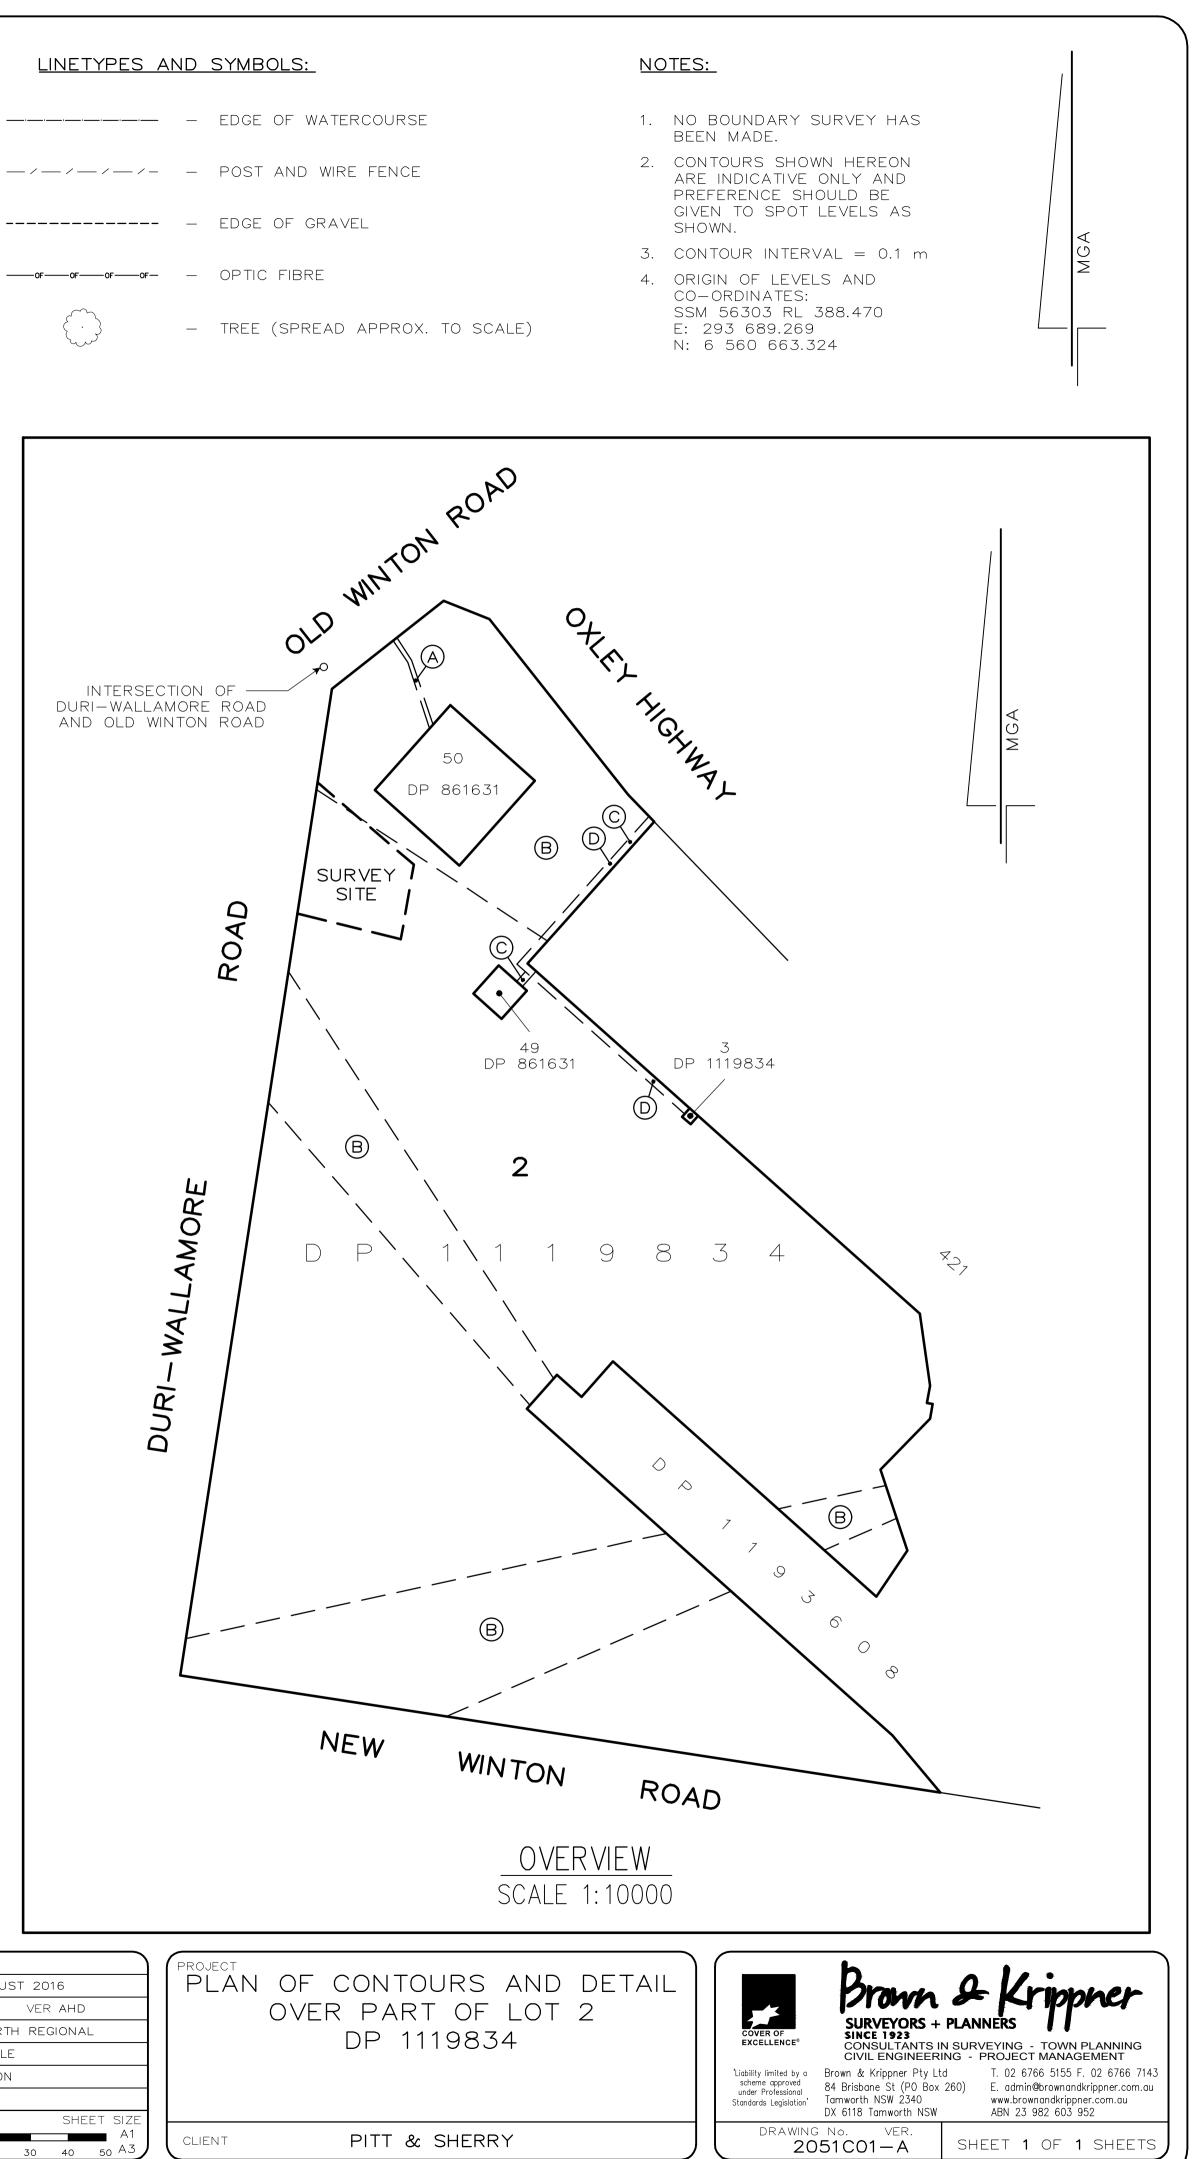
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(A) RIGHT OF CARRIAGEWAY 12 WIDE (DP 861631) (B) restrictions on the use of Land (DP 1119834) (C) RIGHT OF CARRIAGEWAY 20 WIDE (DP 861631) \bigcirc RIGHT OF CARRIAGEWAY 20 WIDE (DP 1119834)

LINETYPES AND SYMBOLS: